

beecroft house 3

no.38a malton road beecroft nsw

architectural list:

page 01 cover page, site plan, basix and roof plan
page 02 floor plans, architectural & sections

1. FALLS, SLIPS, TRIPS

6. HAZARDOUS SUBSTANCES

7. CONFINED SPACES

8. PUBLIC ACCESS

9. OPERATIONAL USE OF BUILDING

10. OTHER HIGH RISK ACTIVITY

11. MANUAL TASKS

12. FALLING OBJECTS

13. TRAFFIC MANAGEMENT

14. SERVICES

15. BUILDING COMPONENTS

16. EXCAVATION

17. TREATED TIMBER

18. VOLATILE ORGANIC COMPOUNDS

19. SYNTHETIC MINERAL FIBRE

20. ASBESTOS

21. POWDERED MATERIALS

22. TREATED TIMBER

23. VOLATILE ORGANIC COMPOUNDS

24. SYNTHETIC MINERAL FIBRE

25. ASBESTOS

26. POWDERED MATERIALS

27. TREATED TIMBER

28. VOLATILE ORGANIC COMPOUNDS

29. SYNTHETIC MINERAL FIBRE

30. ASBESTOS

31. POWDERED MATERIALS

32. TREATED TIMBER

33. VOLATILE ORGANIC COMPOUNDS

34. SYNTHETIC MINERAL FIBRE

35. ASBESTOS

36. POWDERED MATERIALS

37. TREATED TIMBER

38. VOLATILE ORGANIC COMPOUNDS

39. SYNTHETIC MINERAL FIBRE

40. ASBESTOS

41. POWDERED MATERIALS

42. TREATED TIMBER

43. VOLATILE ORGANIC COMPOUNDS

44. SYNTHETIC MINERAL FIBRE

45. ASBESTOS

46. POWDERED MATERIALS

47. TREATED TIMBER

48. VOLATILE ORGANIC COMPOUNDS

49. SYNTHETIC MINERAL FIBRE

50. ASBESTOS

51. POWDERED MATERIALS

52. TREATED TIMBER

53. VOLATILE ORGANIC COMPOUNDS

54. SYNTHETIC MINERAL FIBRE

55. ASBESTOS

56. POWDERED MATERIALS

57. TREATED TIMBER

58. VOLATILE ORGANIC COMPOUNDS

59. SYNTHETIC MINERAL FIBRE

60. ASBESTOS

61. POWDERED MATERIALS

62. TREATED TIMBER

63. VOLATILE ORGANIC COMPOUNDS

64. SYNTHETIC MINERAL FIBRE

65. ASBESTOS

66. POWDERED MATERIALS

67. TREATED TIMBER

68. VOLATILE ORGANIC COMPOUNDS

69. SYNTHETIC MINERAL FIBRE

70. ASBESTOS

71. POWDERED MATERIALS

72. TREATED TIMBER

73. VOLATILE ORGANIC COMPOUNDS

74. SYNTHETIC MINERAL FIBRE

75. ASBESTOS

76. POWDERED MATERIALS

77. TREATED TIMBER

78. VOLATILE ORGANIC COMPOUNDS

79. SYNTHETIC MINERAL FIBRE

80. ASBESTOS

81. POWDERED MATERIALS

82. TREATED TIMBER

83. VOLATILE ORGANIC COMPOUNDS

84. SYNTHETIC MINERAL FIBRE

85. ASBESTOS

86. POWDERED MATERIALS

87. TREATED TIMBER

88. VOLATILE ORGANIC COMPOUNDS

89. SYNTHETIC MINERAL FIBRE

90. ASBESTOS

91. POWDERED MATERIALS

92. TREATED TIMBER

93. VOLATILE ORGANIC COMPOUNDS

94. SYNTHETIC MINERAL FIBRE

95. ASBESTOS

96. POWDERED MATERIALS

97. TREATED TIMBER

98. VOLATILE ORGANIC COMPOUNDS

99. SYNTHETIC MINERAL FIBRE

100. ASBESTOS

101. POWDERED MATERIALS

102. TREATED TIMBER

103. VOLATILE ORGANIC COMPOUNDS

104. SYNTHETIC MINERAL FIBRE

105. ASBESTOS

106. POWDERED MATERIALS

107. TREATED TIMBER

108. VOLATILE ORGANIC COMPOUNDS

109. SYNTHETIC MINERAL FIBRE

110. ASBESTOS

111. POWDERED MATERIALS

112. TREATED TIMBER

113. VOLATILE ORGANIC COMPOUNDS

114. SYNTHETIC MINERAL FIBRE

115. ASBESTOS

116. POWDERED MATERIALS

117. TREATED TIMBER

118. VOLATILE ORGANIC COMPOUNDS

119. SYNTHETIC MINERAL FIBRE

120. ASBESTOS

121. POWDERED MATERIALS

122. TREATED TIMBER

123. VOLATILE ORGANIC COMPOUNDS

124. SYNTHETIC MINERAL FIBRE

125. ASBESTOS

126. POWDERED MATERIALS

127. TREATED TIMBER

128. VOLATILE ORGANIC COMPOUNDS

129. SYNTHETIC MINERAL FIBRE

130. ASBESTOS

131. POWDERED MATERIALS

132. TREATED TIMBER

133. VOLATILE ORGANIC COMPOUNDS

134. SYNTHETIC MINERAL FIBRE

135. ASBESTOS

136. POWDERED MATERIALS

137. TREATED TIMBER

138. VOLATILE ORGANIC COMPOUNDS

139. SYNTHETIC MINERAL FIBRE

140. ASBESTOS

141. POWDERED MATERIALS

142. TREATED TIMBER

143. VOLATILE ORGANIC COMPOUNDS

144. SYNTHETIC MINERAL FIBRE

145. ASBESTOS

146. POWDERED MATERIALS

147. TREATED TIMBER

148. VOLATILE ORGANIC COMPOUNDS

149. SYNTHETIC MINERAL FIBRE

150. ASBESTOS

151. POWDERED MATERIALS

152. TREATED TIMBER

153. VOLATILE ORGANIC COMPOUNDS

154. SYNTHETIC MINERAL FIBRE

155. ASBESTOS

156. POWDERED MATERIALS

157. TREATED TIMBER

158. VOLATILE ORGANIC COMPOUNDS

159. SYNTHETIC MINERAL FIBRE

160. ASBESTOS

161. POWDERED MATERIALS

162. TREATED TIMBER

163. VOLATILE ORGANIC COMPOUNDS

164. SYNTHETIC MINERAL FIBRE

165. ASBESTOS

166. POWDERED MATERIALS

167. TREATED TIMBER

168. VOLATILE ORGANIC COMPOUNDS

169. SYNTHETIC MINERAL FIBRE

170. ASBESTOS

171. POWDERED MATERIALS

172. TREATED TIMBER

173. VOLATILE ORGANIC COMPOUNDS

174. SYNTHETIC MINERAL FIBRE

175. ASBESTOS

176. POWDERED MATERIALS

177. TREATED TIMBER

178. VOLATILE ORGANIC COMPOUNDS

179. SYNTHETIC MINERAL FIBRE

180. ASBESTOS

181. POWDERED MATERIALS

182. TREATED TIMBER

183. VOLATILE ORGANIC COMPOUNDS

184. SYNTHETIC MINERAL FIBRE

185. ASBESTOS

186. POWDERED MATERIALS

187. TREATED TIMBER

188. VOLATILE ORGANIC COMPOUNDS

189. SYNTHETIC MINERAL FIBRE

190. ASBESTOS

191. POWDERED MATERIALS

192. TREATED TIMBER

193. VOLATILE ORGANIC COMPOUNDS

194. SYNTHETIC MINERAL FIBRE

195. ASBESTOS

196. POWDERED MATERIALS

197. TREATED TIMBER

198. VOLATILE ORGANIC COMPOUNDS

199. SYNTHETIC MINERAL FIBRE

200. ASBESTOS

201. POWDERED MATERIALS

202. TREATED TIMBER

203. VOLATILE ORGANIC COMPOUNDS

204. SYNTHETIC MINERAL FIBRE

205. ASBESTOS

206. POWDERED MATERIALS

207. TREATED TIMBER

208. VOLATILE ORGANIC COMPOUNDS

209. SYNTHETIC MINERAL FIBRE

210. ASBESTOS

211. POWDERED MATERIALS

212. TREATED TIMBER

213. VOLATILE ORGANIC COMPOUNDS

214. SYNTHETIC MINERAL FIBRE

215. ASBESTOS

216. POWDERED MATERIALS

217. TREATED TIMBER

218. VOLATILE ORGANIC COMPOUNDS

219. SYNTHETIC MINERAL FIBRE

220. ASBESTOS

221. POWDERED MATERIALS

222. TREATED TIMBER

223. VOLATILE ORGANIC COMPOUNDS

224. SYNTHETIC MINERAL FIBRE

225. ASBESTOS

226. POWDERED MATERIALS

227. TREATED TIMBER

228. VOLATILE ORGANIC COMPOUNDS

229. SYNTHETIC MINERAL FIBRE

230. ASBESTOS

231. POWDERED MATERIALS

232. TREATED TIMBER

233. VOLATILE ORGANIC COMPOUNDS

234. SYNTHETIC MINERAL FIBRE

235. ASBESTOS

236. POWDERED MATERIALS

237. TREATED TIMBER

238. VOLATILE ORGANIC COMPOUNDS

239. SYNTHETIC MINERAL FIBRE

240. ASBESTOS

241. POWDERED MATERIALS

242. TREATED TIMBER

243. VOLATILE ORGANIC COMPOUNDS

244. SYNTHETIC MINERAL FIBRE

245. ASBESTOS

246. POWDERED MATERIALS

247. TREATED TIMBER

248. VOLATILE ORGANIC COMPOUNDS

249. SYNTHETIC MINERAL FIBRE

250. ASBESTOS

251. POWDERED MATERIALS

252. TREATED TIMBER

253. VOLATILE ORGANIC COMPOUNDS

254. SYNTHETIC MINERAL FIBRE

255. ASBESTOS

256. POWDERED MATERIALS

257. TREATED TIMBER

258. VOLATILE ORGANIC COMPOUNDS

259. SYNTHETIC MINERAL FIBRE

260. ASBESTOS

261. POWDERED MATERIALS

262. TREATED TIMBER

263. VOLATILE ORGANIC COMPOUNDS

264. SYNTHETIC MINERAL FIBRE

265. ASBESTOS

266. POWDERED MATERIALS


267. TREATED TIMBER

268. VOLATILE ORGANIC COMPOUNDS


269. SYNTHETIC MINERAL FIBRE

270. ASBESTOS


271. POWDERED MATERIALS

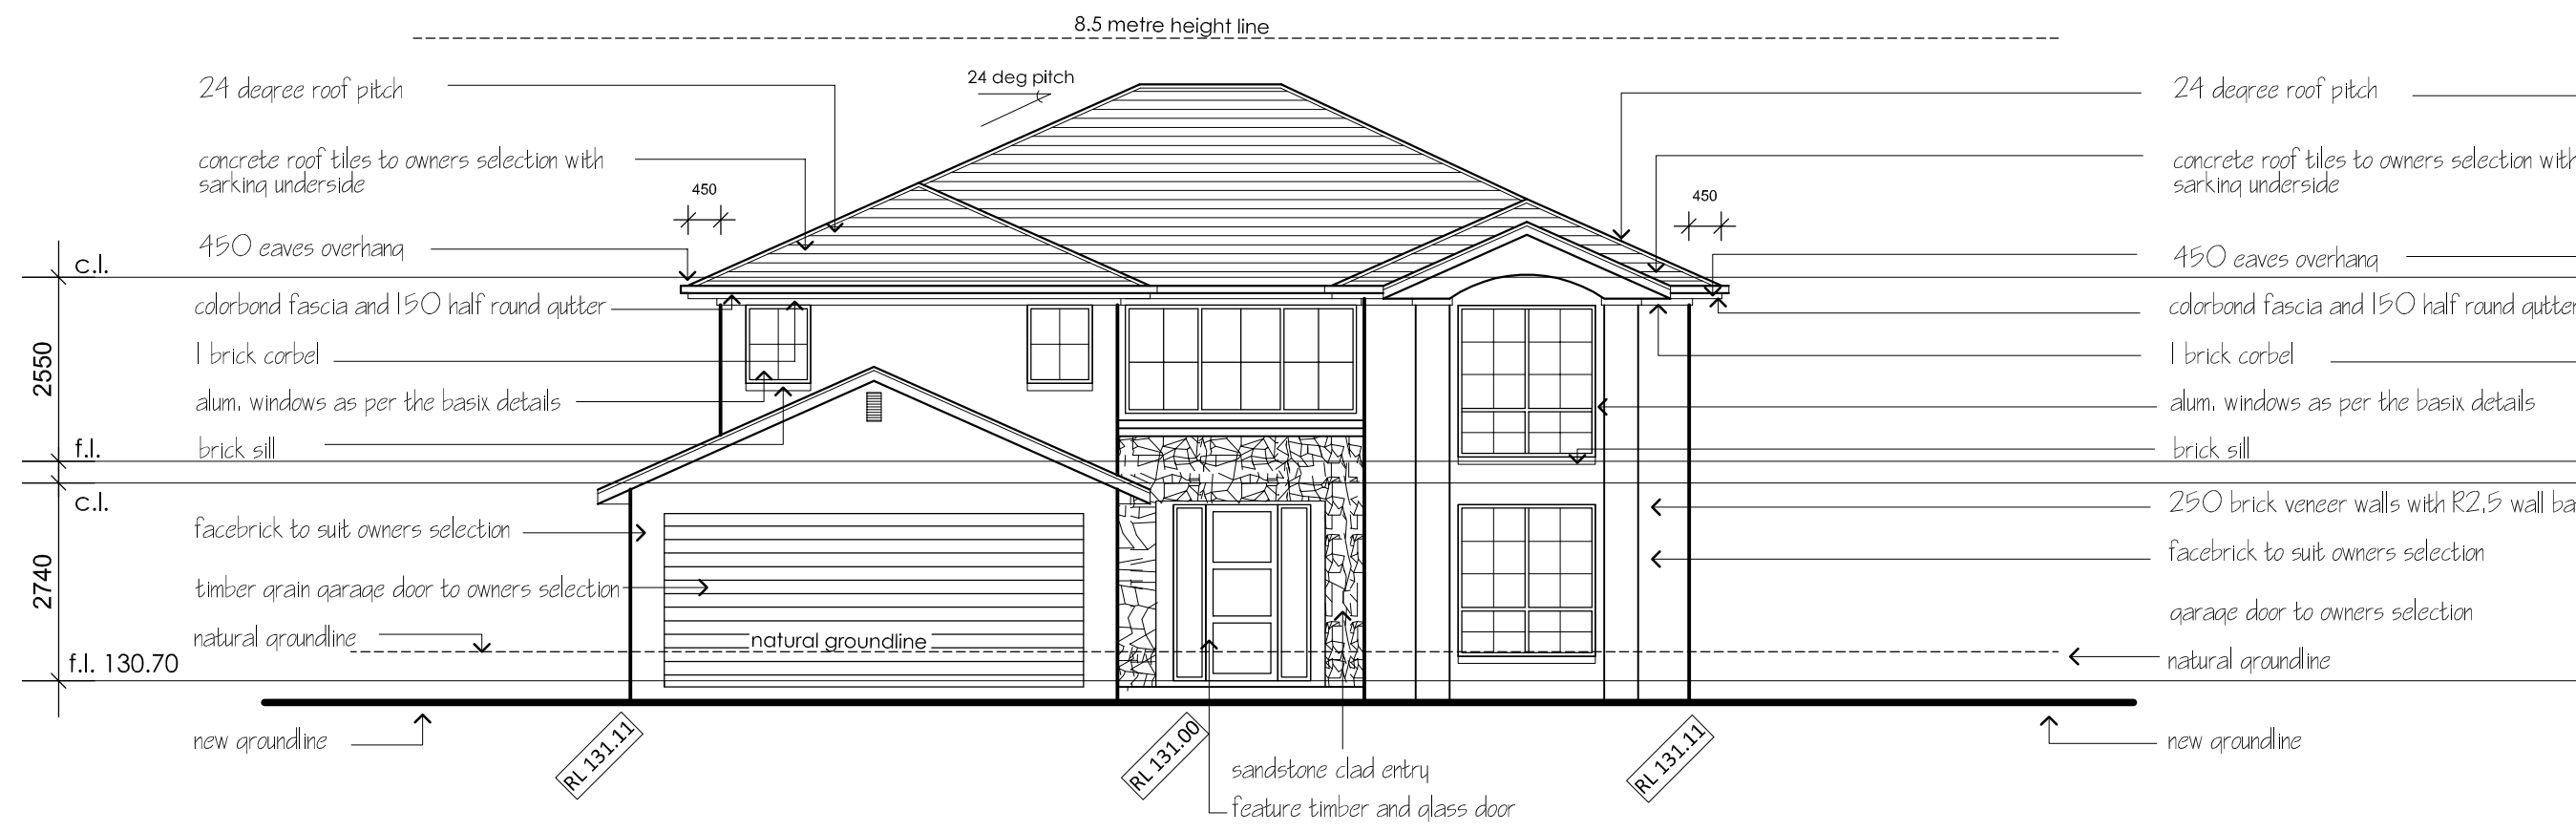


north elevation. (scale 1:100)

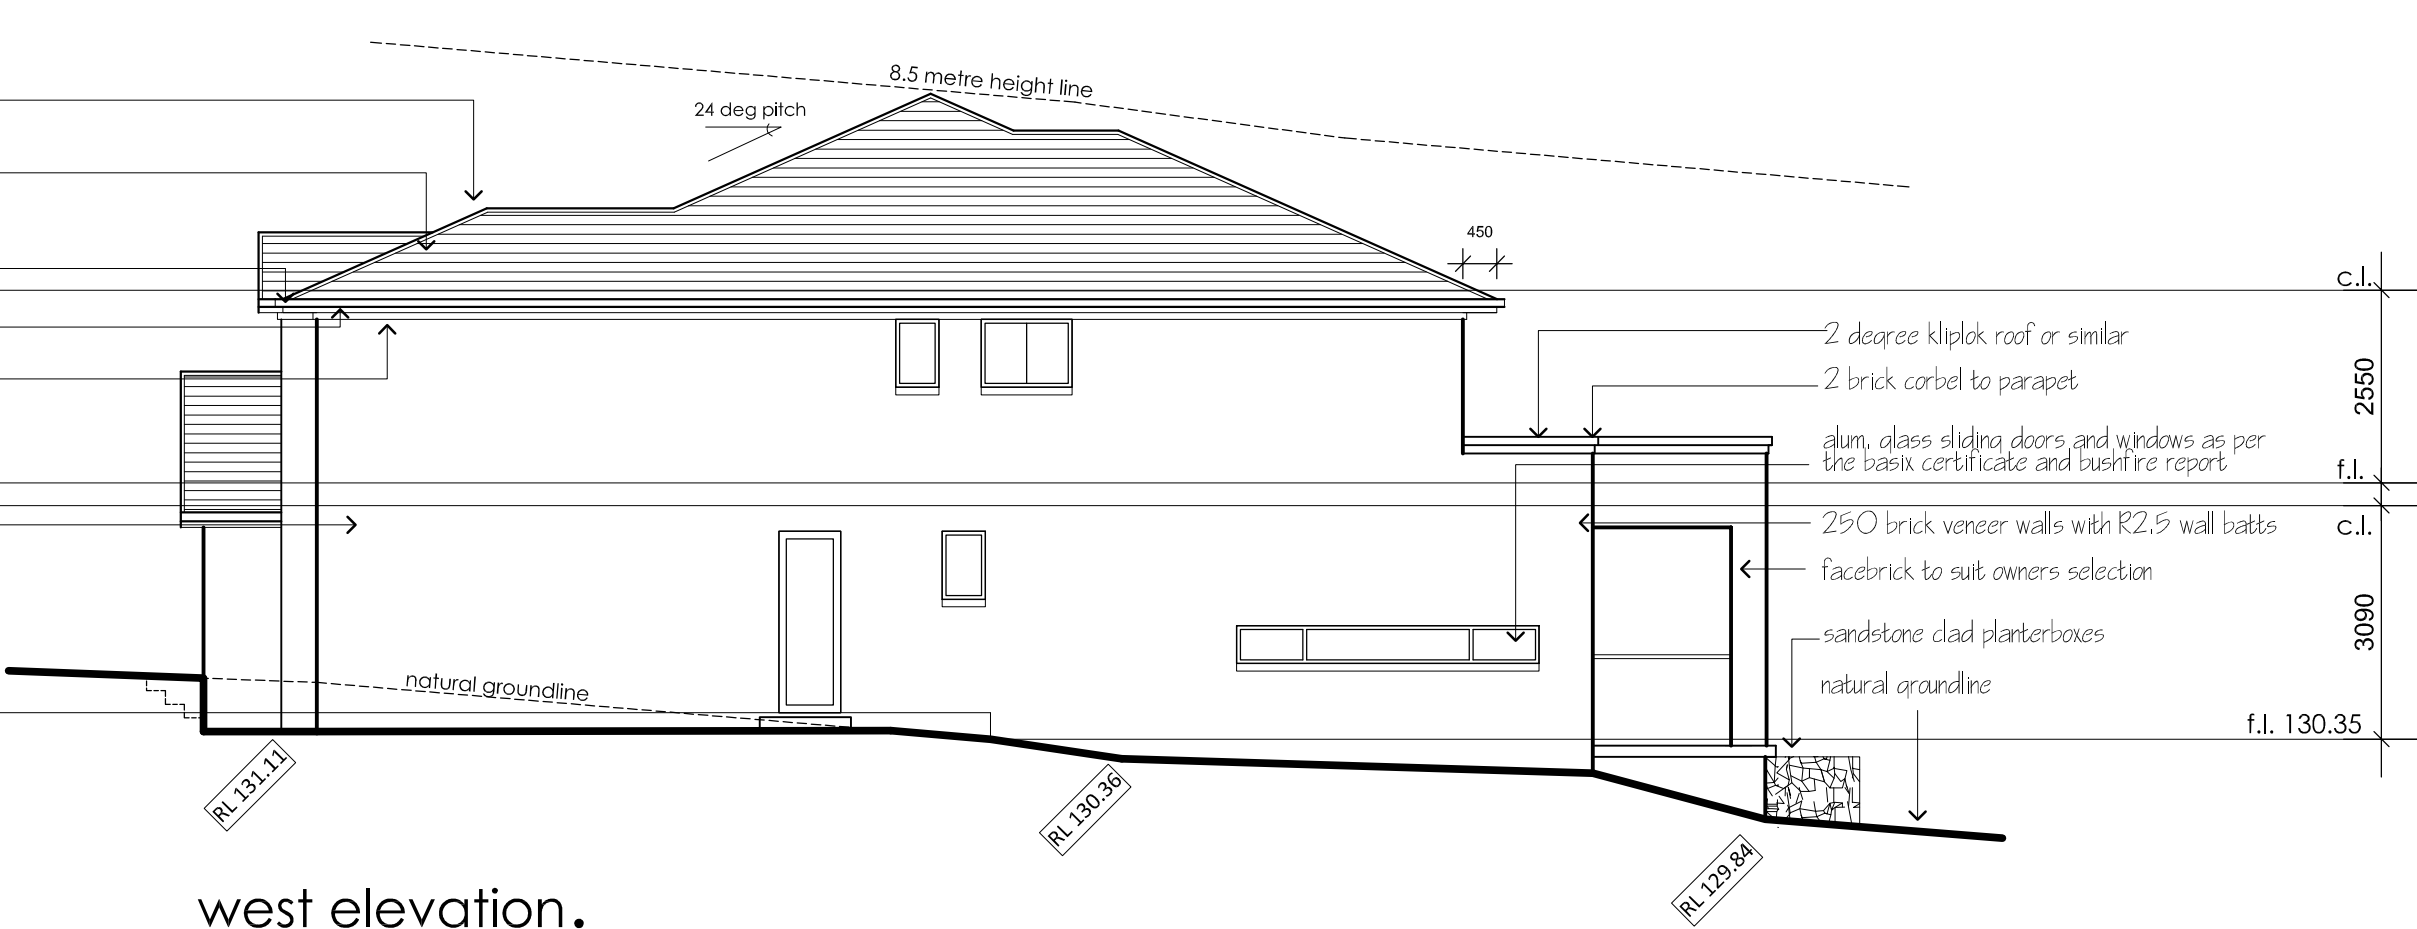


west elevation.

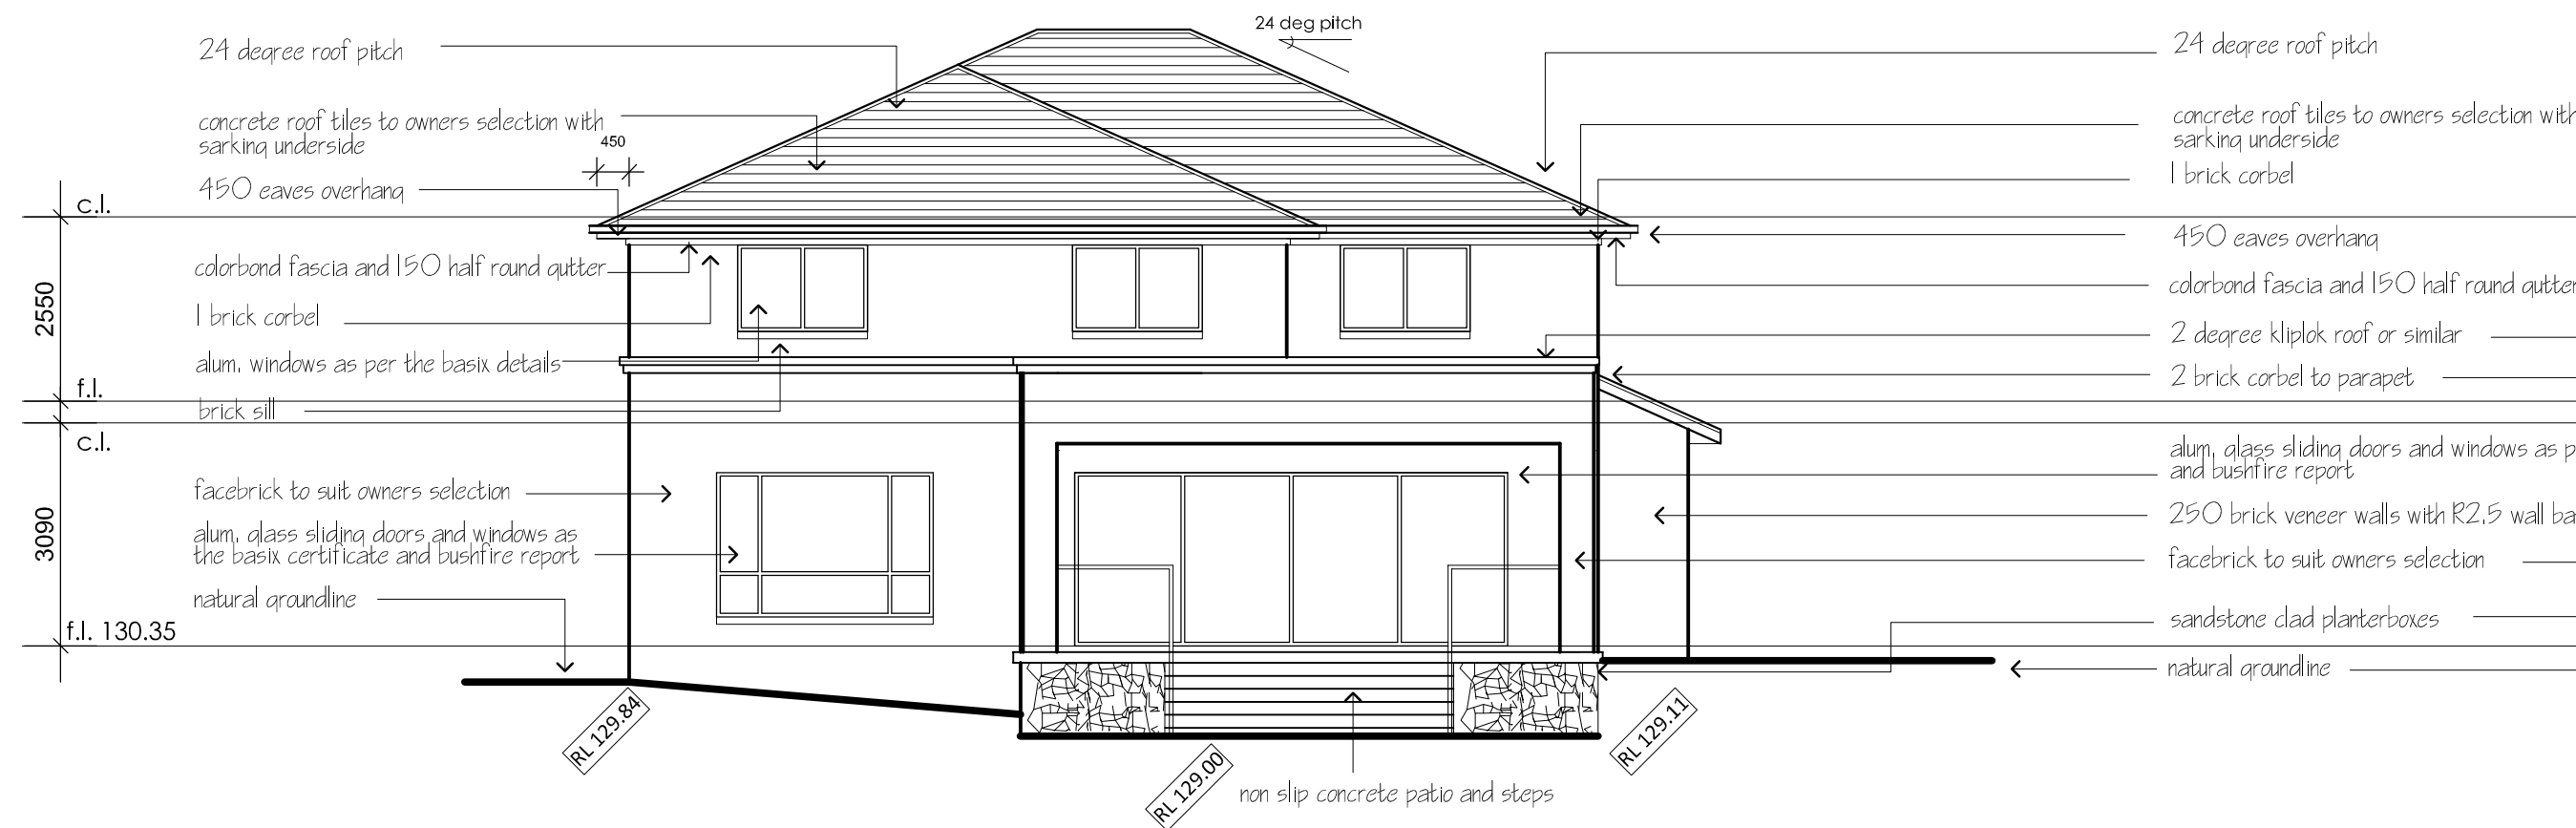


south elevation.

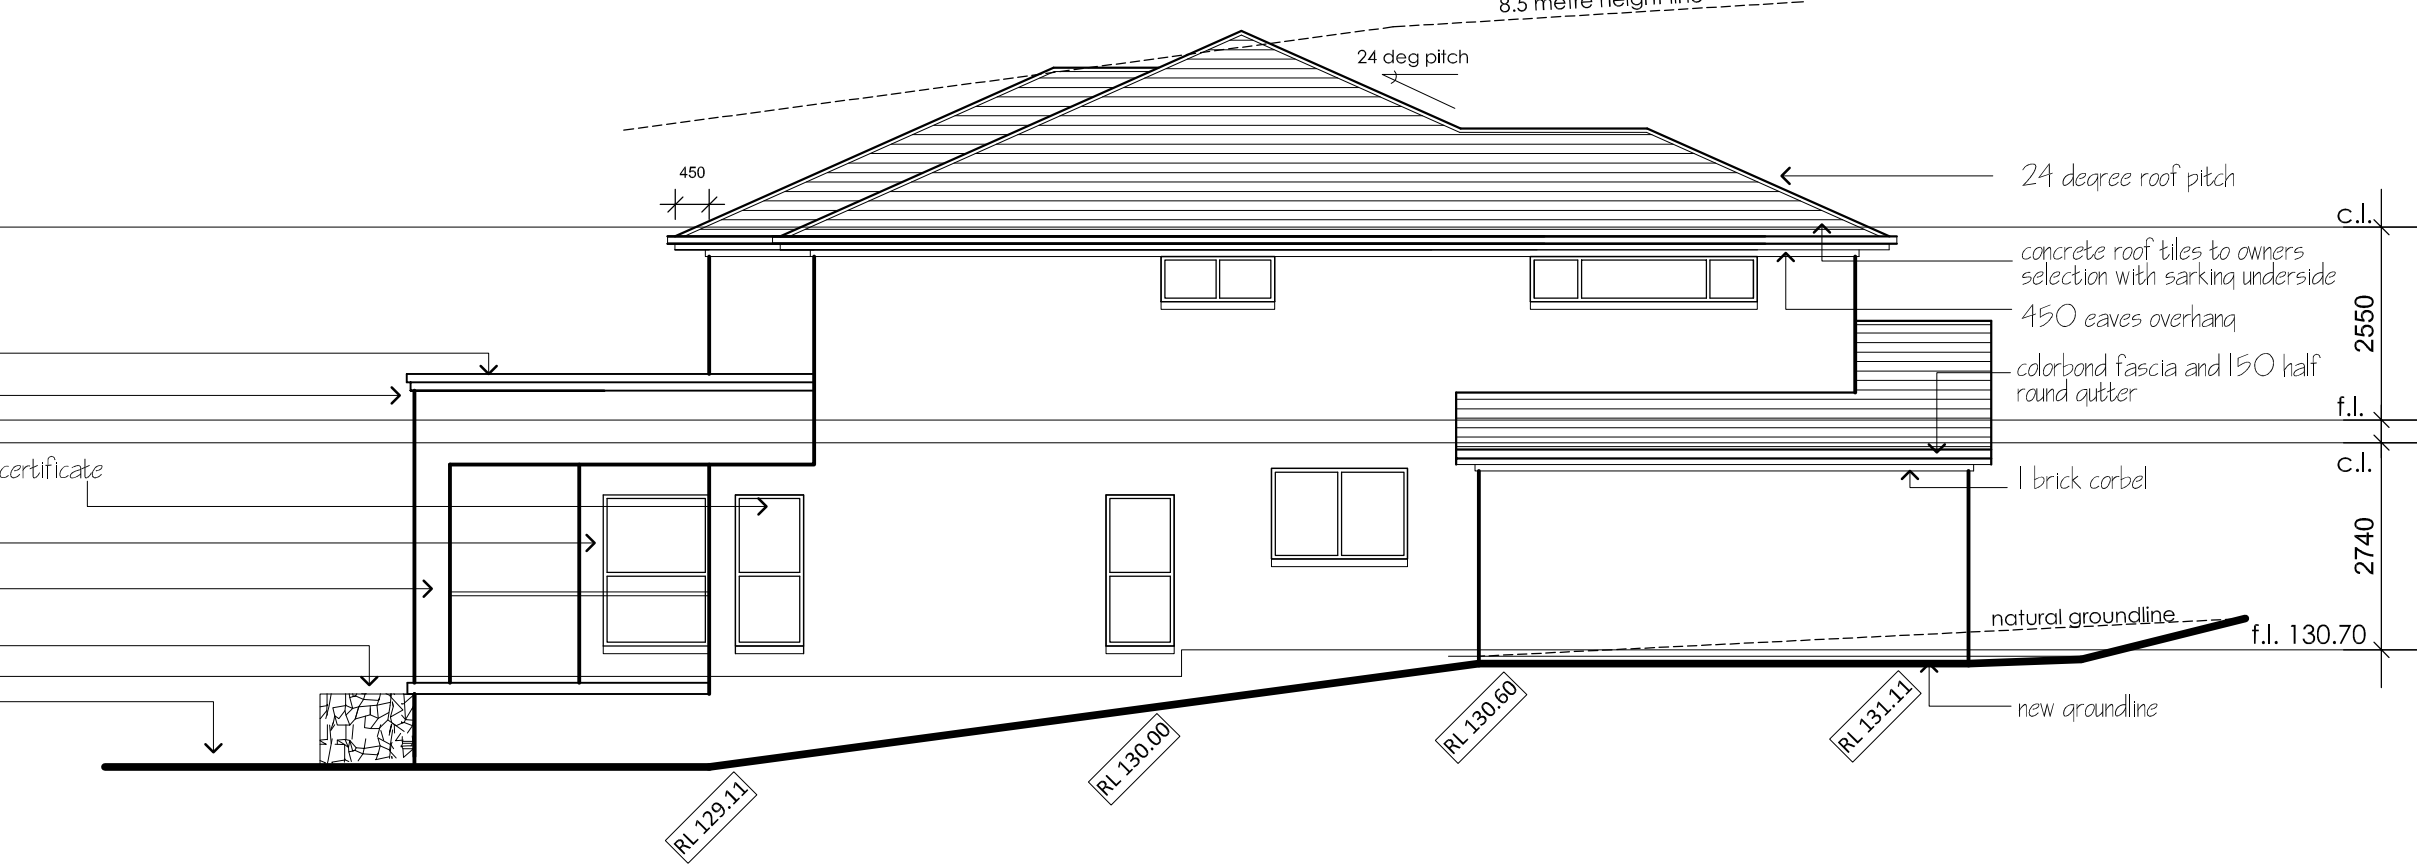


east elevation.

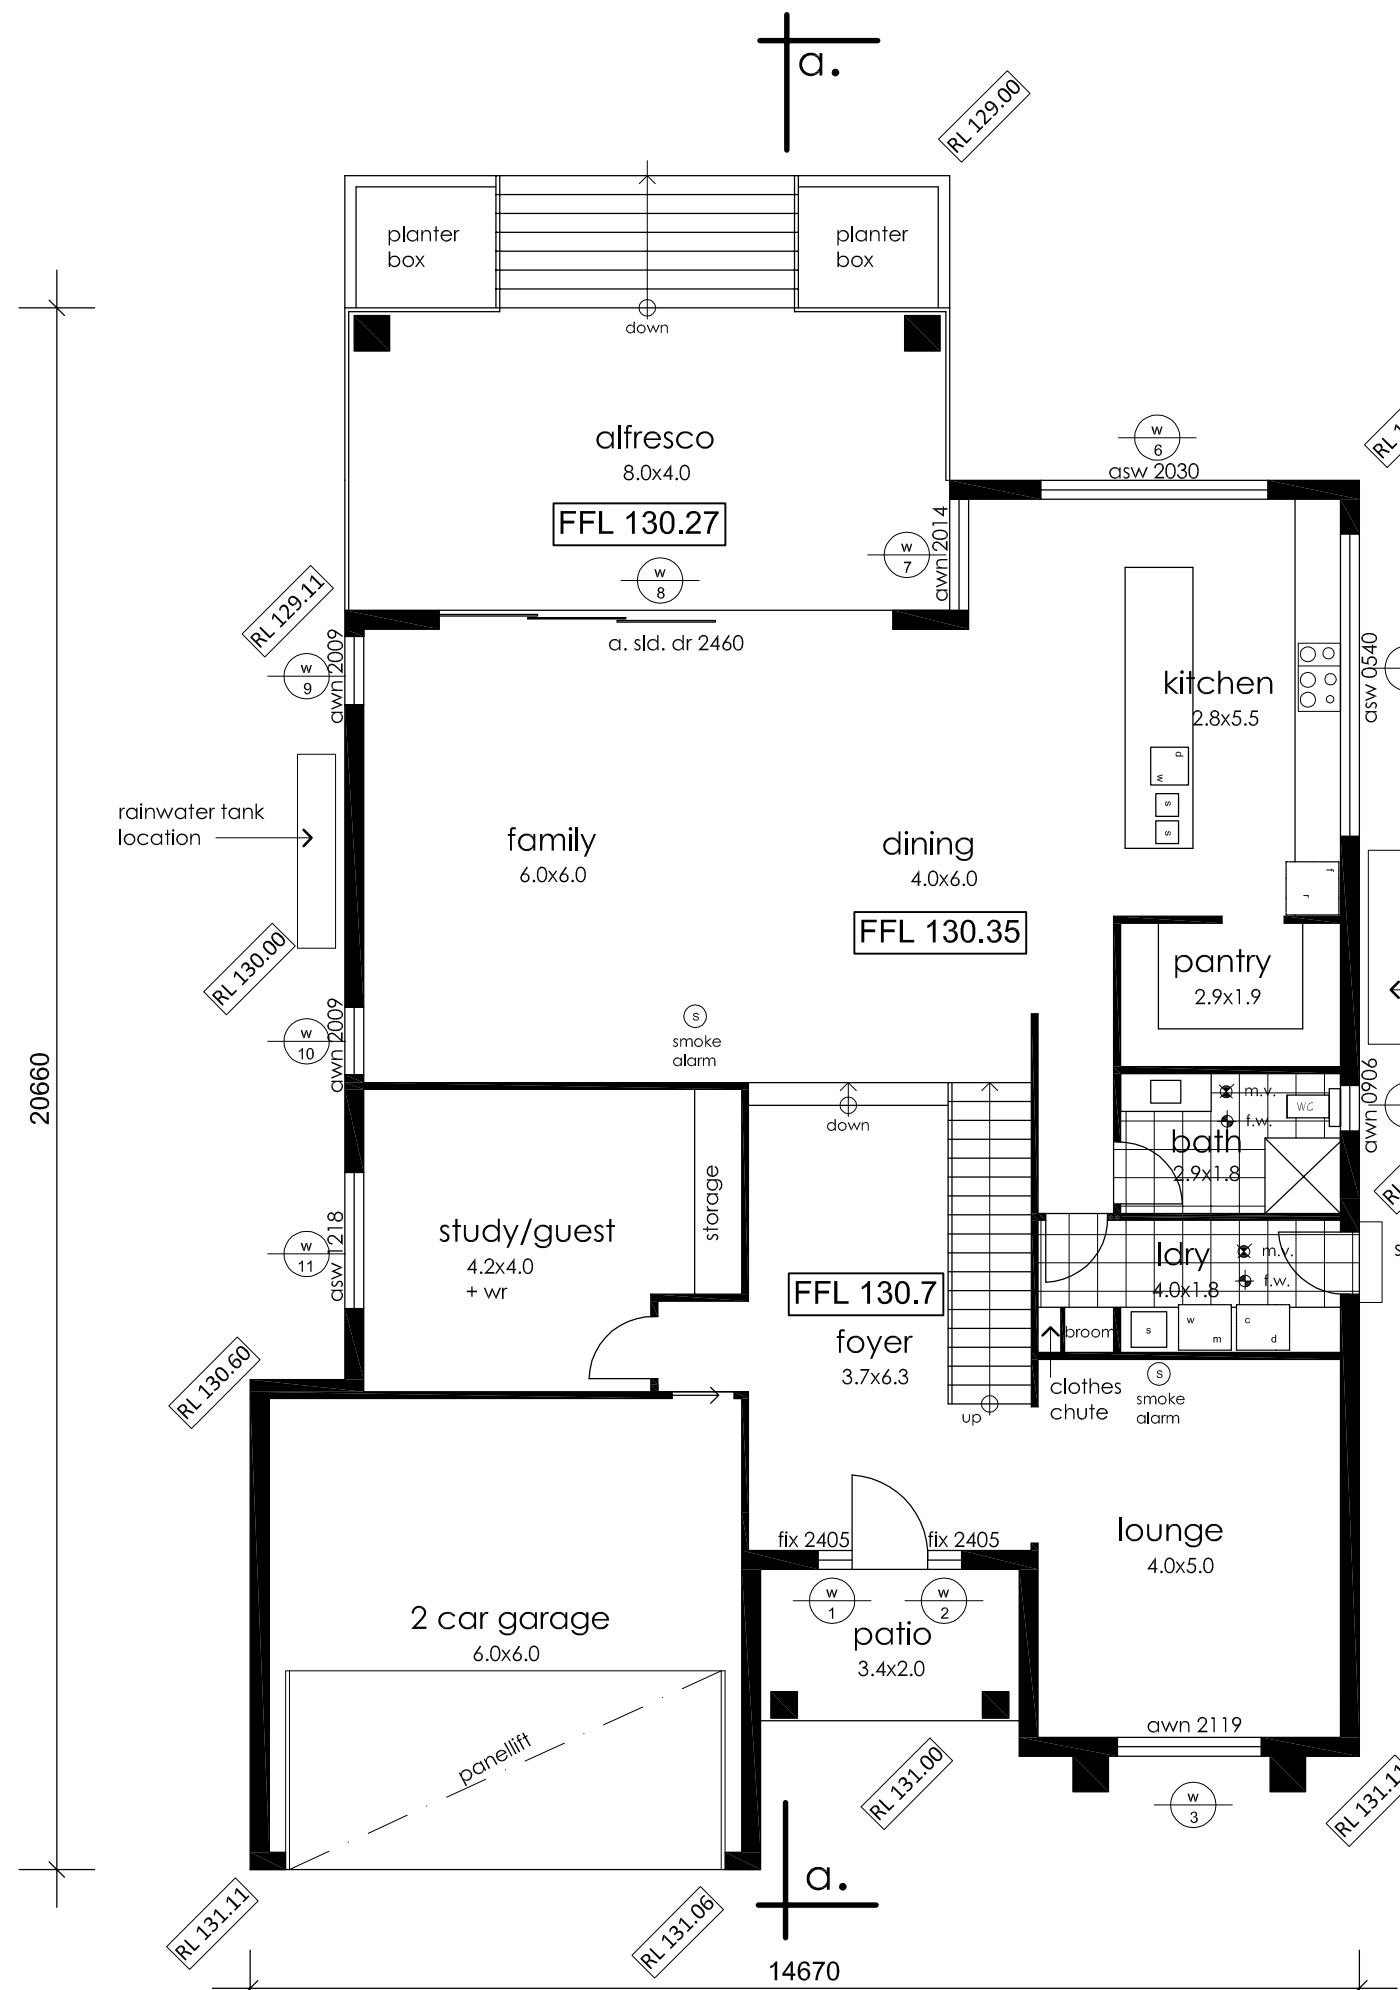

ground floor plan. (scale 1:100)

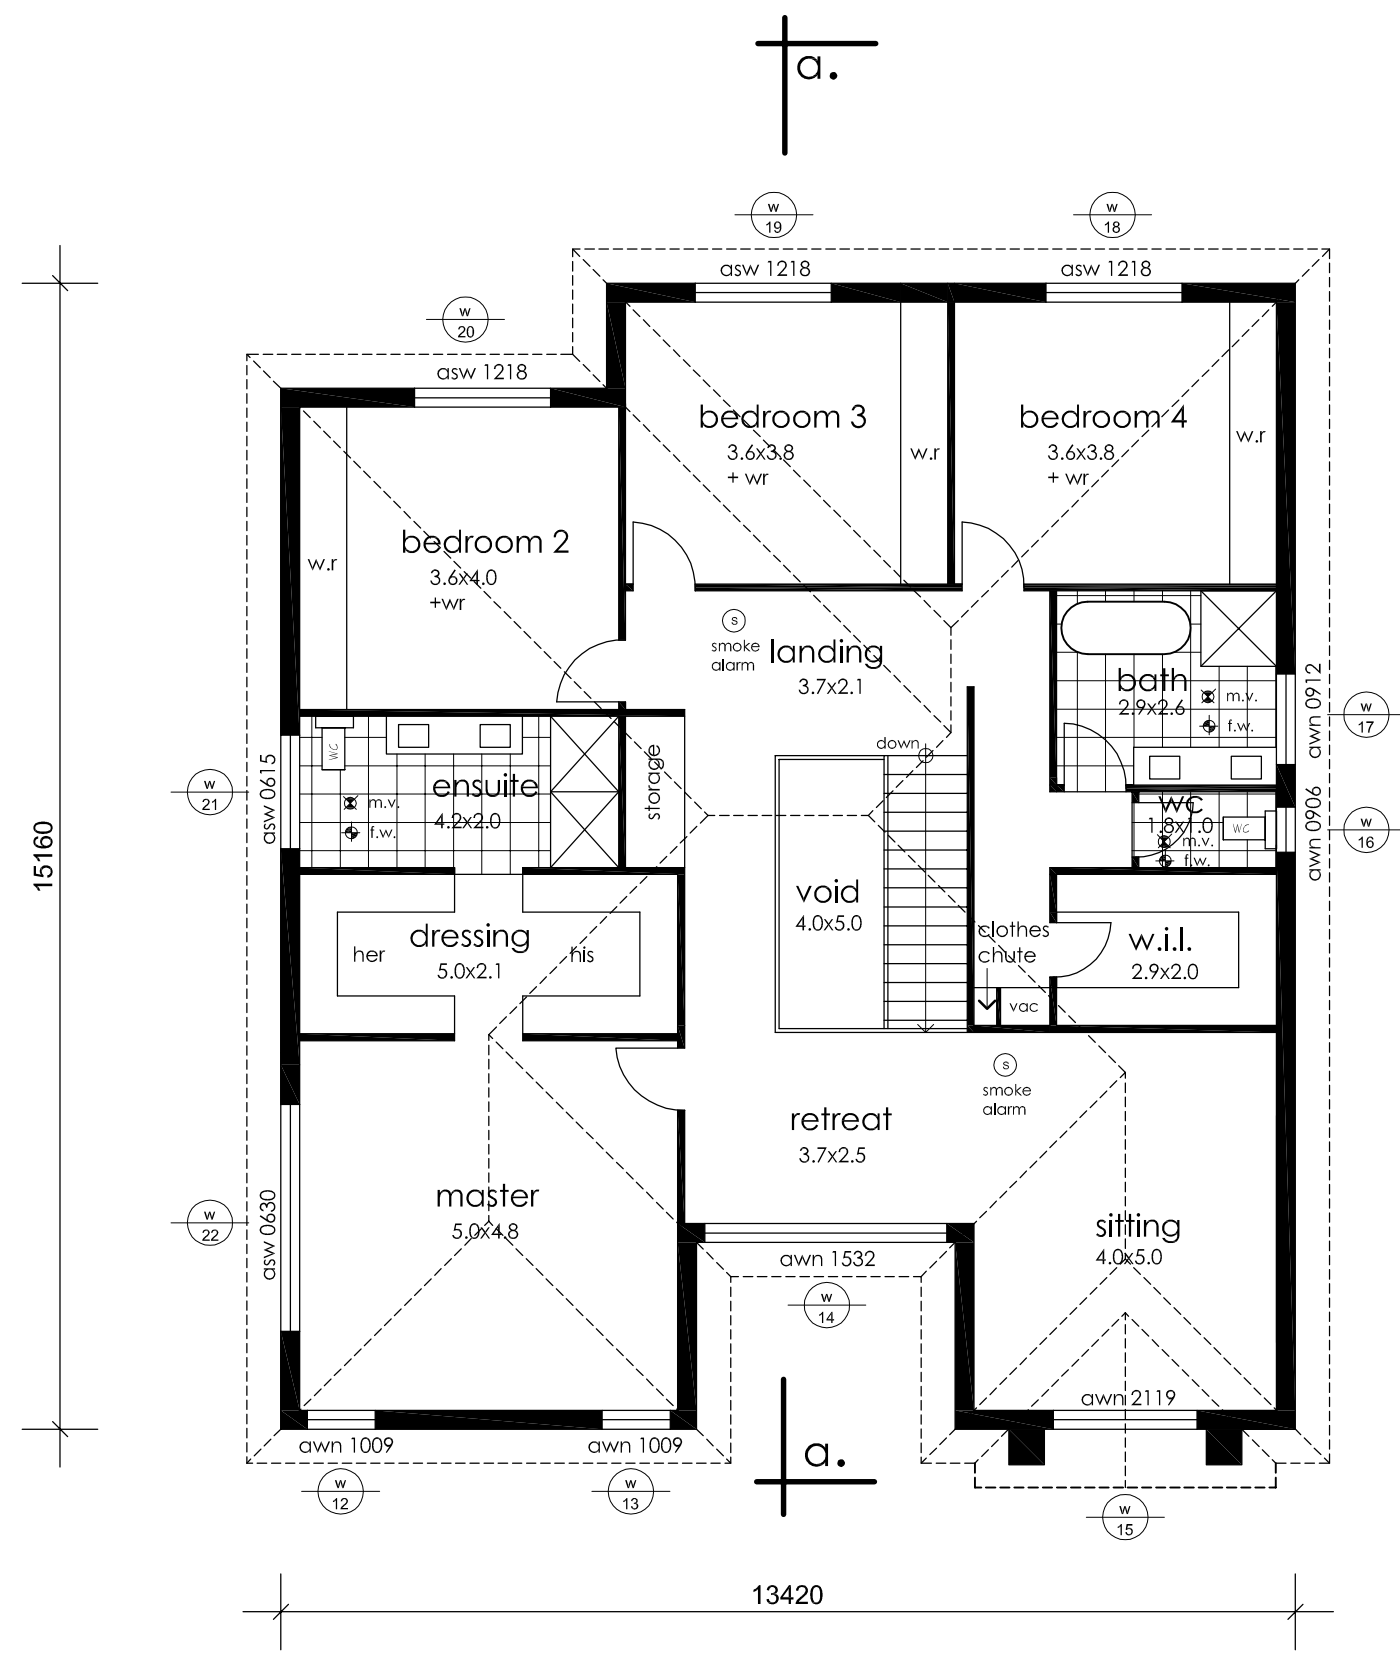


top floor plan.

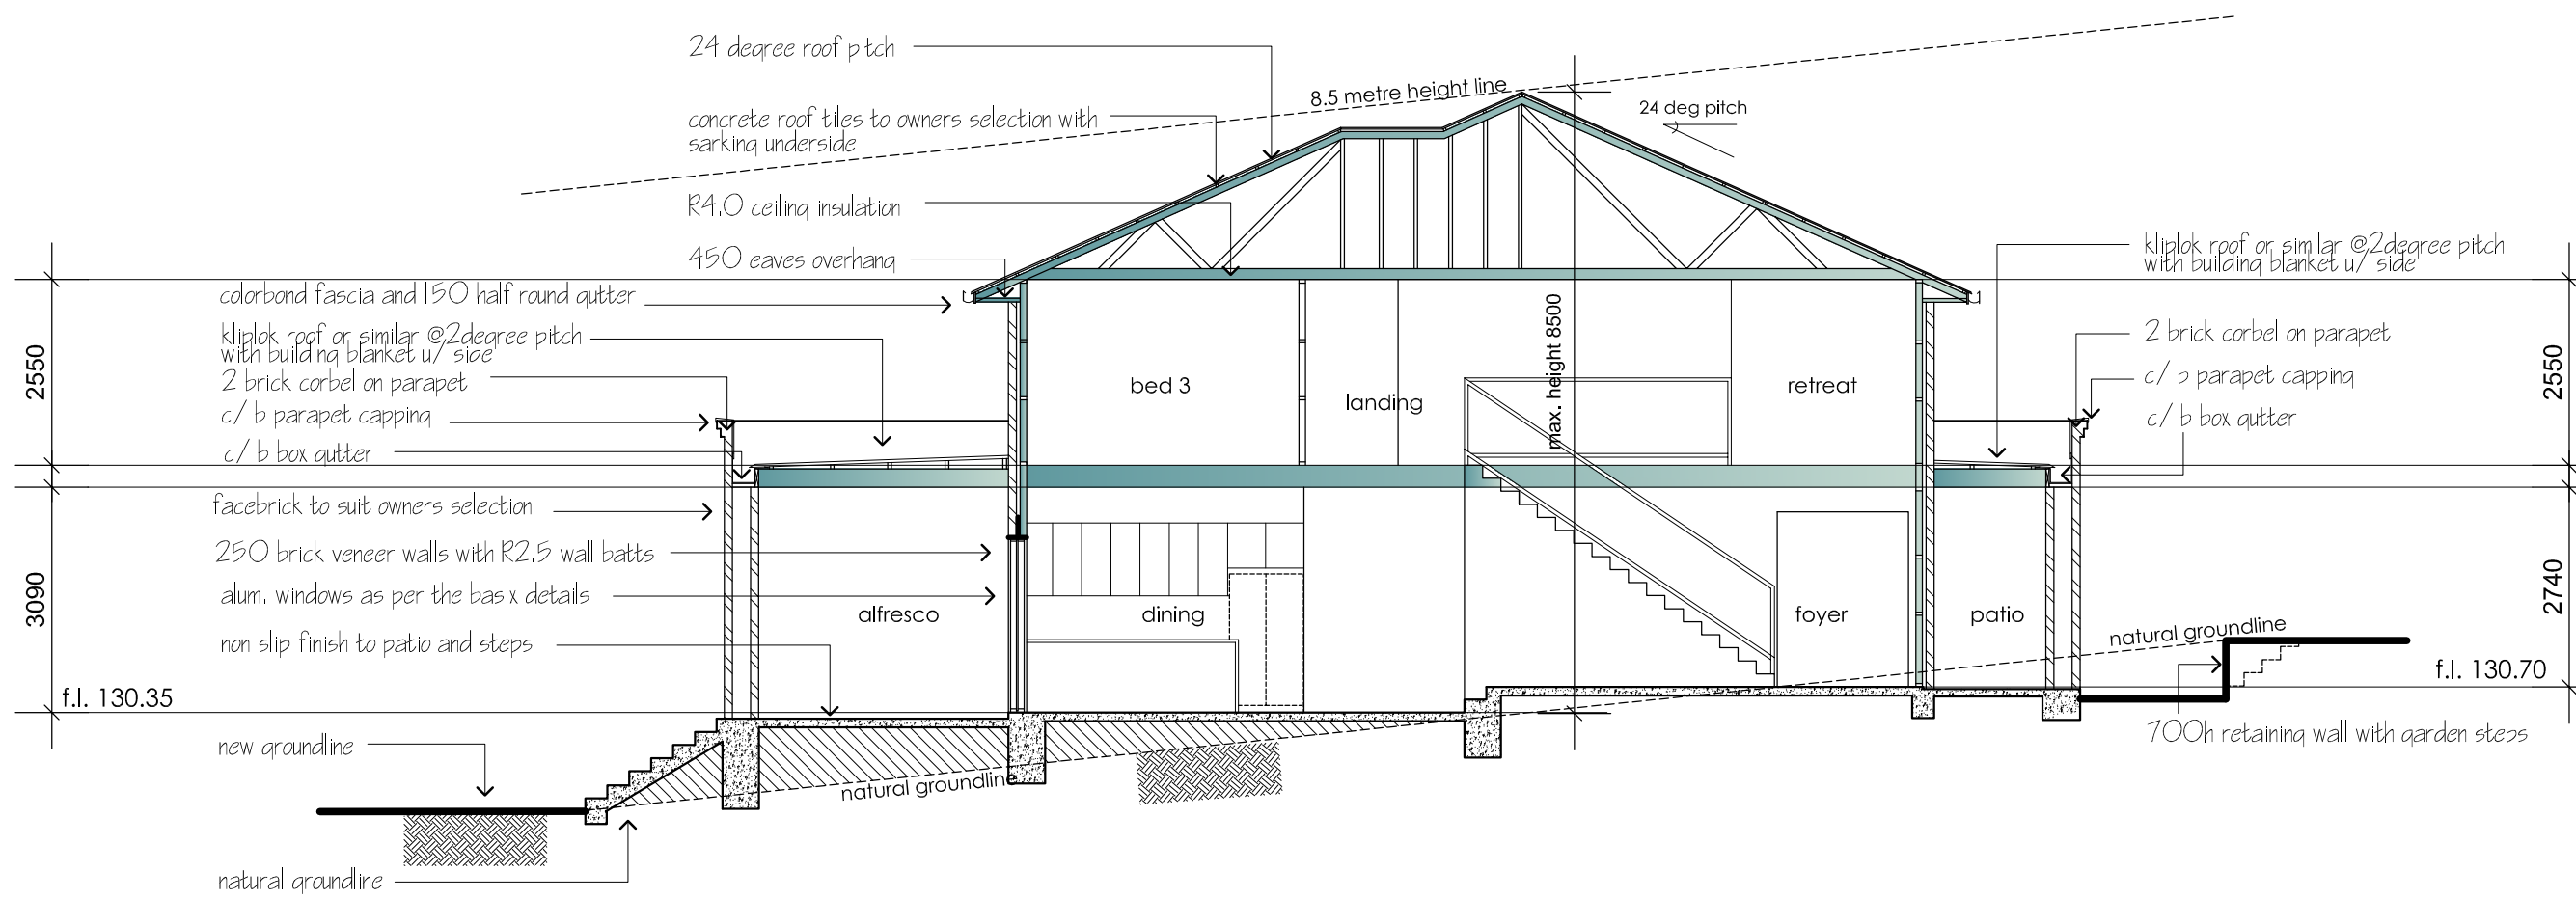

section a-a. (scale 1:100)

bushfire prone site BAL 29

note:
all windows must be site measured prior to manufacture. All windows performance specifications must be as per the basix certificate. Any discrepancies must be related back to the designer prior to manufacture. Windows must meet the child safety standards of NCC 3.9.2.5

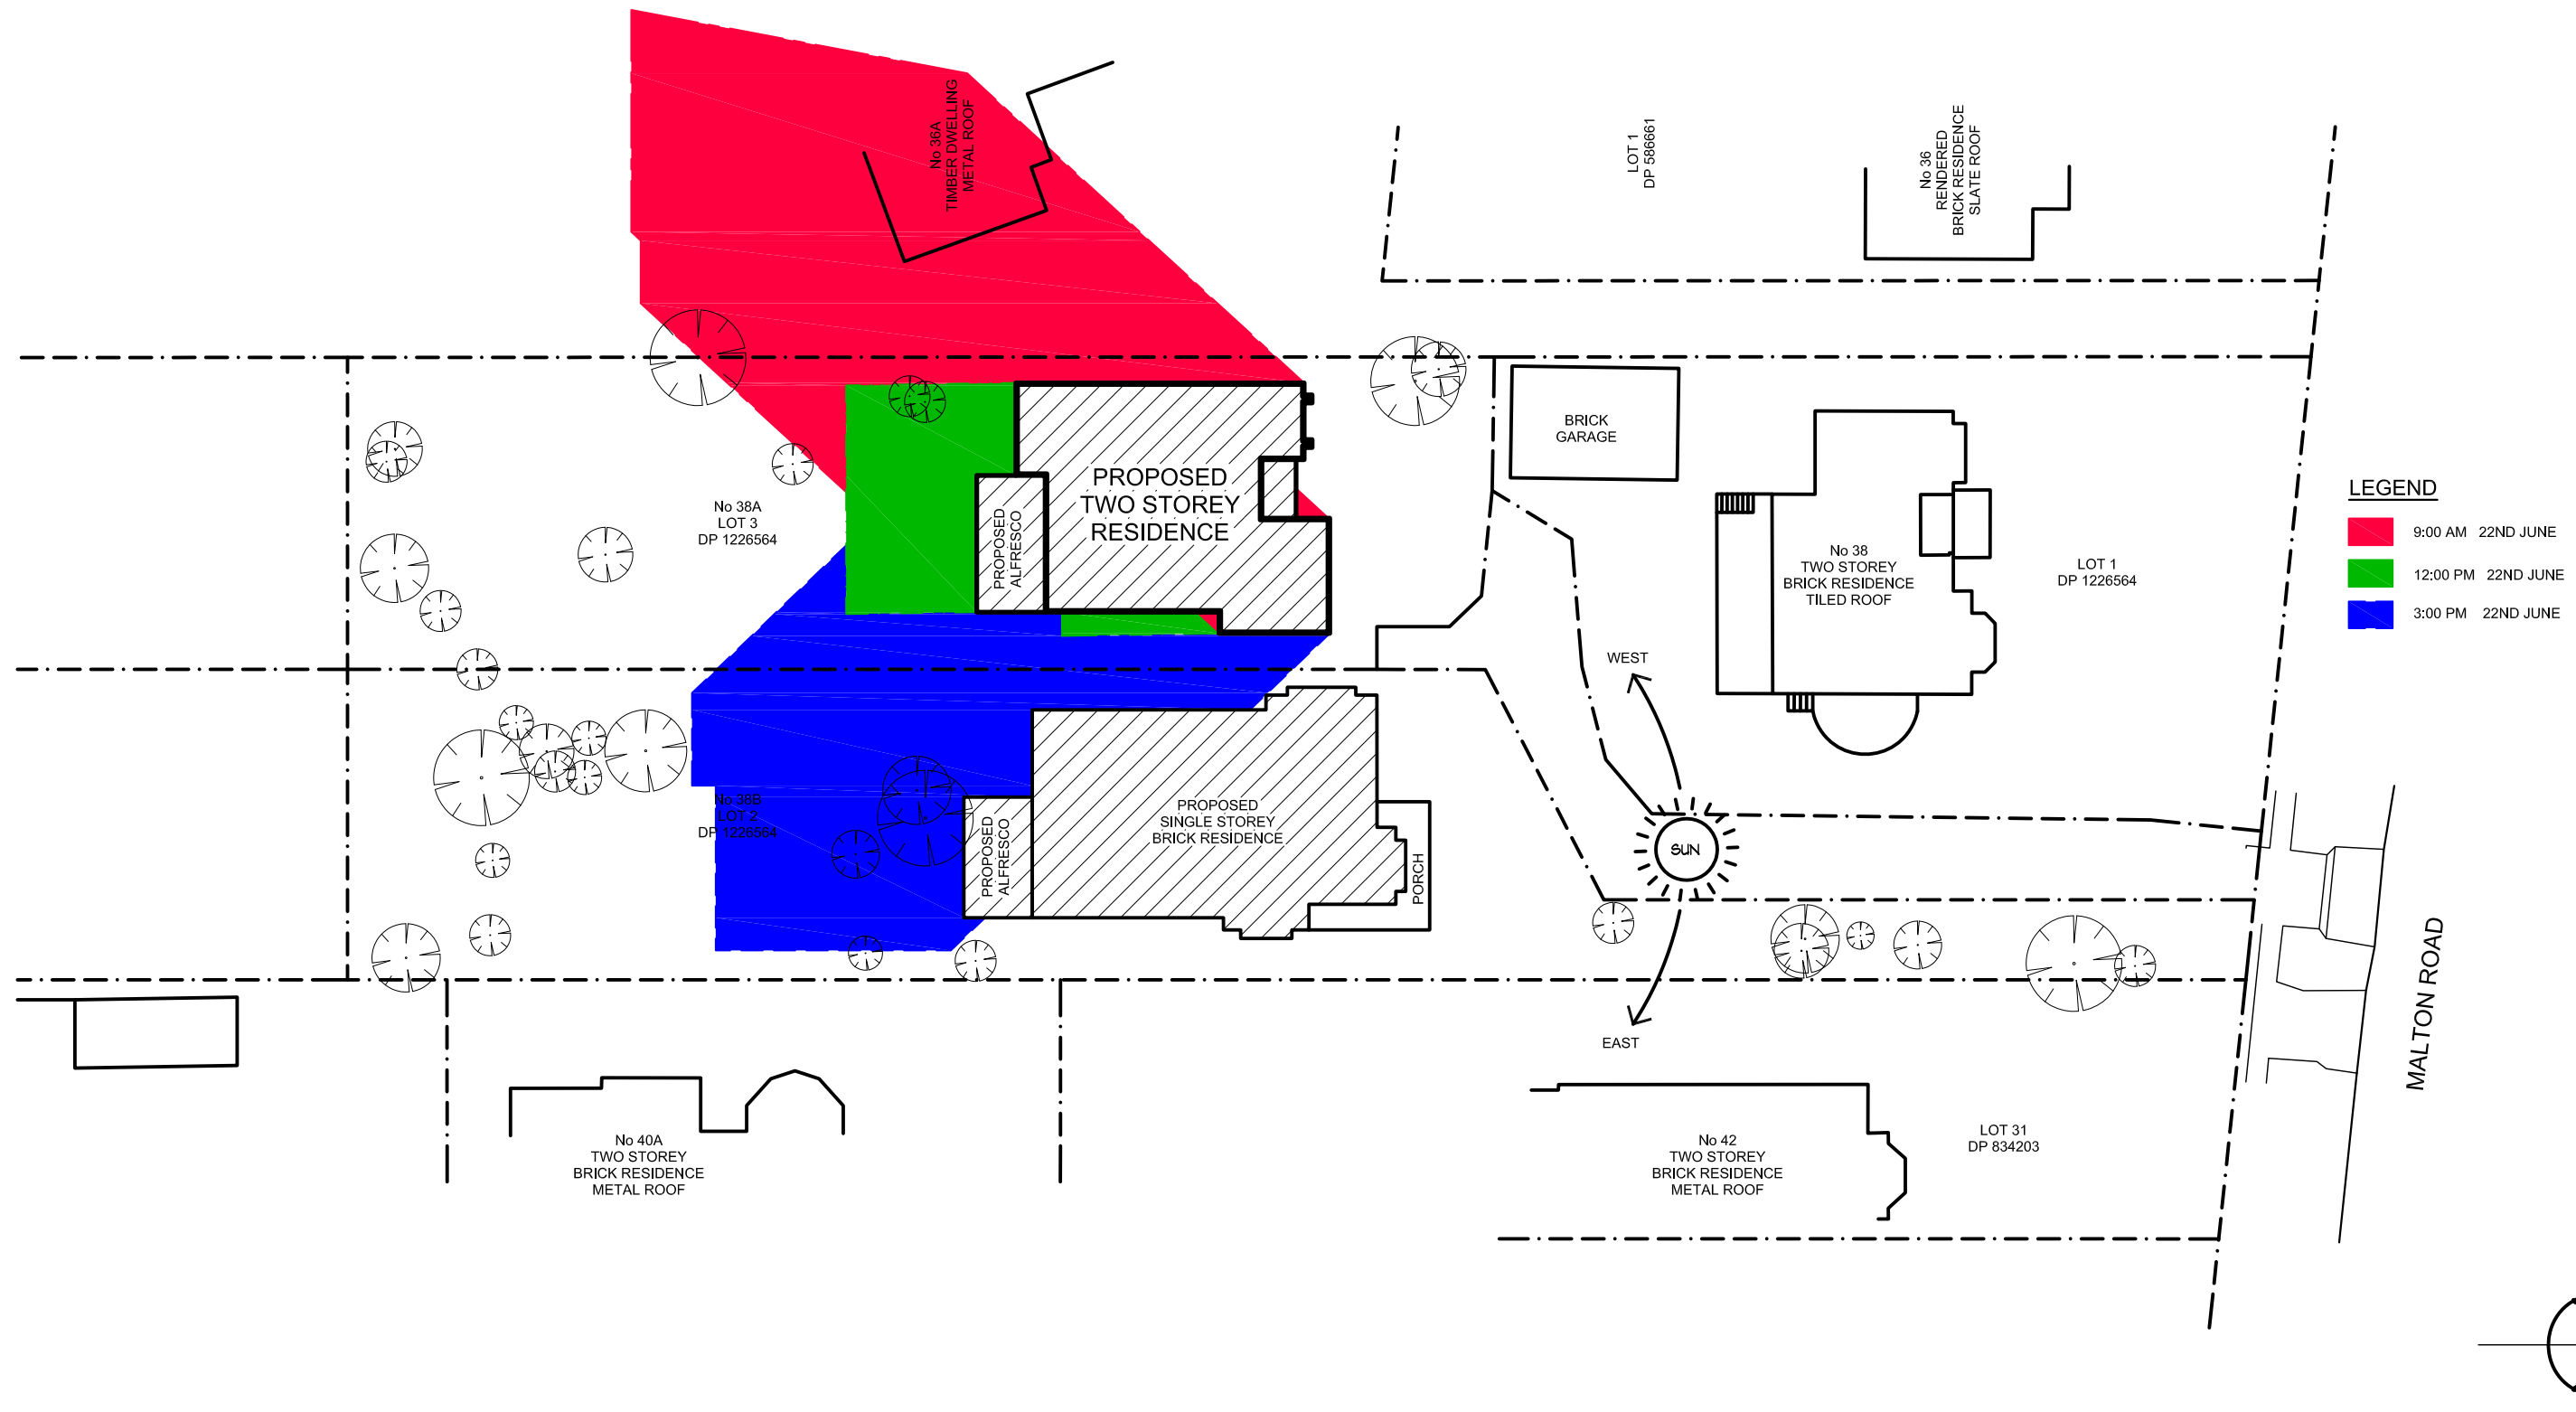

NY Project Services Pty Ltd
Mob: 0403 280 297
111 Barnier Drive, Quakers Hill, NSW 2763

REV.	DATE	DESCRIPTION
A	19/08/2020	DA ISSUE

PROJECT LOCATION LOT 3 DP1226564 38A MALTON ROAD, BEECROFT		
DRAWN BY YH	DATE PLOTTED 19/08/2020	SCRIPT FILE/S N/A
CAD REFERENCE		XREF/S N/A

TITLE SHADOW DIAGRAMS
PROJECT PROPOSED TWO STOREY DWELLING

FIGURED DIMENSIONS TO BE TAKEN IN PREFERENCE TO SCALED READINGS. VERIFY ALL DIMENSIONS ON SITE.	
SCALE 1:400	REV A
DRAWING No. SD-01	