## Certificate number: 1242480S\_03

Assessor Certificate to the application for an occupation certificate for the proposed development.  The Assessor Certificate must have been issued by an Accredited Assessor in accordance with the Thermal Comfort Protocol.  The details of the proposed development on the Assessor Certificate must be consistent with the details shown in this BASIX certificate, including the Cooling and Heating loads shown on the front page of this certificate.  The applicant must show on the plans accompanying the development application for the proposed development, all matters which the Assessor Certificate requires to be shown on those plans. Those plans must been a stamp of endorsement from the Accredited Assessor to certify that this is the case. The applicant must show on the plans accompanying the application for a construction certificate (or complying development certificate, all thermal performance specifications set out in the Assessor Certificate, and all aspects of the development which were used to calculate those specifications.  The applicant must construct the development in accordance with all thermal performance specifications set out in the Assessor Certificate, and in accordance with those aspects of the development application for a complying development certificate.	Water Commitments	Show on DA plans	Show on CC/CDC plans & specs	Certifier check
The applicant must install a tollet flushing system with a minimum rating of 4 star in each tollet in the development.  The applicant must install taps with a minimum rating of 4 star in the kitchen in the development.  The applicant must install basin taps with a minimum rating of 4 star in each bathroom in the development.  Alternative water  Rainwater tank  The applicant must install a rainwater tank of at least 3000 litres on the site. This rainwater tank must meet, and be installed in accordance with, the requirements of all applicable regulatory authorities.  The applicant must configure the rainwater tank to collect rain runoff from at least 255 square metres of the roof area of the development (excluding the area of the roof which drains to any stomwater tank or private dam).  The applicant must connect the rainwater tank to:  all tollets in the development  the cold water tap that supplies each clothes washer in the development  at least one outdoor tap in the development (Note: NSW Health does not recommend that rainwater be used for human consumption in areas with potable water supply.)  Thermal Comfort Commitments  Show on DA plans  Show on DA plans  Show on DA plans  Show on CCICDC plans & specs  Certificate  The development application and construction certificate for the proposed development (or, if the applicant is applying for a complying development certificate for the proposed development.)  The Assessor Certificate in the development application and construction certificate to the proposed development.  The Assessor development application and construction certificate to the proposed development.  The Assessor Certificate must have been issued by an Accredited Assessor in accordance with ith the details shown in this BASIX certificate.  The Assessor of the proposed development application for an occupation or and construction certificate for the proposed development.  The applicant must show on the plans accompanying the development application for the proposed development.  The applicant mu	Fixtures			
The applicant must install taps with a minimum rating of 4 star in the kitchen in the development.  The applicant must install basin taps with a minimum rating of 4 star in each bathroom in the development.  Alternative water  Rainwater tank  The applicant must install a rainwater tank of at least 3000 litres on the site. This rainwater tank must meet, and be installed in accordance with, the requirements of all applicable regulatory authorities.  The applicant must configure the rainwater tank to collect rain unoff from at least 235 square metres of the roof area of the development square to the roof which drains to any stormwater tank or private dam).  The applicant must connect the rainwater tank to:  all totales in the development  the oold water tap that supplies each clothes washer in the development  at least one outdoor raip in the development (Note: NSW Health does not recommend that rainwater be used for human consumption in areas with potable water supply.)  Thermal Comfort Commitments  Simulation Method  The applicant must attach the certificate referred to under "Assessor Details" on the front page of this BASIX certificate (the "Assessor Certificate") to the development application and construction certificate application for the proposed development (or, if the applicant hust also attach the Assessor Certificate in the application must also attach the Assessor Certificate in the application must also attach the Assessor Certificate must have been issued by an Accredited Assessor in accordance with the Thermal Comfort Protocol.  The details of the proposed development on the Assessor Certificate must be consistent with the details shown in this BASIX certificate requires to be shown on those plans. Those plans must bear a stamp of endorsement from the Accredited experiment and the certificate requires to be shown on the front page of this certificate.  The applicant must show on the plans accompanying the development application for the proposed development, and matters which the Assessor Certific	The applicant must install showerheads with a minimum rating of 3 star (> 7.5 but <= 9 L/min) in all showers in the development.		~	~
Alternative water  Rainwater tank The applicant must install basin taps with a minimum rating of 4 star in each bathroom in the development.  Alternative water  Rainwater tank The applicant must install a rainwater tank of at least 3000 litres on the site. This rainwater tank must meet, and be installed in accordance with, the requirements of all applicable regulatory authorities.  The applicant must configure the rainwater tank to collect rain runoff from at least 235 square metres of the roof vince development (excluding the area of the roof winch drains to any stormwater tank or private dam).  The applicant must connect the rainwater tank to:  all tollets in the development  the development (Note: NSW Health does not recommend that rainwater be used for human consumption in areas with potable water supply.)  Thermal Comfort Commitments  Show on DA plans  Show on CC/CDD plans & specs  Simulation Method  The applicant must attach the certificate referred to under "Assessor Details" on the front page of this BASIX certificate (the "Assessor Certificate") to the development application and construction certificate application for the proposed development (or, if the applicant is applying for a complying development certificate for the proposed development.) The applicant must also attach the Assessor Certificate to the application for on an occupation certificate for the proposed development. The applicant must also attach the Assessor Certificate to the application for an occupation certificate for the proposed development.  The details of the proposed development on the Assessor Certificate in the plans accompanying the development application for the proposed development.  The applicant must show on the plans accompanying the development application for the proposed development.  The applicant must show on the plans accompanying the development application for the proposed development application for the proposed development application for a complying development eerflicate it applicable), all themsel perfor	The applicant must install a toilet flushing system with a minimum rating of 4 star in each toilet in the development.		~	~
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The applicant must construct the development in accordance with all thermal performance specifications set out in the Assessor Certificate, and in accordance with those aspects of the development application or application for a complying development certificate which were used to calculate those specifications.  The applicant must construct the floors and walls of the dwelling in accordance with the specifications listed in the table below.	Assessor Certificate requires to be shown on those plans. Those plans must bear a stamp of endorsement from the Accredited Assessor to certify that this is the case. The applicant must show on the plans accompanying the application for a construction certificate (or complying development certificate, if applicable, all thermal performance specifications set out in the Assessor	~	~	~
The applicant must construct the floors and walls of the dwelling in accordance with the specifications listed in the table below.	Certificate, and in accordance with those aspects of the development application or application for a complying development certificate		~	~
	The applicant must construct the floors and walls of the dwelling in accordance with the specifications listed in the table below.	V	V	V

floor - concrete slab on ground	153.0 square metres			
floor - suspended floor/open subfloor	4.0 square metres			
floor - suspended floor above garage	All or part of floor area			
Energy Commitments		Show on DA plans	Show on CC/CDC plans & specs	Certifier check
Hot water				
The applicant must install the following hot water system in the development, or a system with instantaneous with a performance of $6$ stars.	a higher energy rating: gas	~	~	~
Cooling system				
The applicant must install the following cooling system, or a system with a higher energy rating airconditioning; Energy rating: EER $3.0 - 3.5$	g, in at least 1 living area: 3-phase		V	v
The applicant must install the following cooling system, or a system with a higher energy rating airconditioning; Energy rating: EER $3.0$ - $3.5$	g, in at least 1 bedroom: 3-phase		~	V
The cooling system must provide for day/night zoning between living areas and bedrooms.				U
Heating system				
The applicant must install the following heating system, or a system with a higher energy ratin airconditioning; Energy rating: EER 3.0 - 3.5 $$			V	V
The applicant must install the following heating system, or a system with a higher energy ratin airconditioning; Energy rating: EER $3.0$ - $3.5$	g, in at least 1 bedroom: 3-phase		V	~
The heating system must provide for day/night zoning between living areas and bedrooms.			~	~
Ventilation				
The applicant must install the following exhaust systems in the development:				
At least 1 Bathroom: individual fan, not ducted; Operation control: manual switch on/off			V	V
Kitchen: individual fan, ducted to façade or roof; Operation control: manual switch on/off				J
Laundry: natural ventilation only, or no laundry; Operation control: n/a			Ü	J
Artificial lighting				
The applicant must ensure that the "primary type of artificial lighting" is fluorescent or light emi following rooms, and where the word "dedicated" appears, the fittings for those lights must on light emitting idode (LED) lamps:	itting diode (LED) lighting in each of the by be capable of accepting fluorescent or			
at least 5 of the bedrooms / study; dedicated				
at least 5 of the living / dining rooms; dedicated		 		
the kitchen; dedicated			, and the second	3
all bathrooms/toilets; dedicated			J	J
the laundry; dedicated			Ü	J
all hallways; dedicated			Ü	J
Natural lighting			•	
The applicant must install a window and/or skylight in the kitchen of the dwelling for natural lig	hting.	· ·	U U	U
The applicant must install a window and/or skylight in 3 bathroom(s)/toilet(s) in the development	ent for natural lighting.	J	J	-
Other				
The applicant must install a gas cooktop & electric oven in the kitchen of the dwelling.		T		
The applicant must install a fixed outdoor clothes drying line as part of the development.			_	-
THE MET STORE STOR			~	
The applicant must install a fixed indoor or sheltered clothes drying line as part of the develop	ment.		<b>V</b>	



#### **CABANA**

AREAS	
SITE:	886.00 m²
GROUND FLOOR:	24.96 m²
FIRST FLOOR: GARAGE:	N/A m² N/A m²
PORCH:	0 m²
BALCONY:	N/A m²
	m²
	m²
TOTAL:	24.96 m²

### MAIN DWELLING

886.00 m²
170.97 m²
180.97 m²
40.56 m <sup>2</sup>
10.59 m²
6.48 m <sup>2</sup>
45.52 m²
m²
455.09 m²

2.5 SHADOW DIAGRAM DEC. 21ST2.4 SHADOW DIAGRAM JUNE21ST2.3 NEIGHBOUR NOTIFICATION PLAN

	2.2	SITE ANALYSIS PLAN
	2.1	SOIL & WATER MANAGEMENT
	14	WET AREA DETAILS
	13	WET AREA DETAILS
	12	WET AREA DETAILS
MJ	11	G.F. ELECTRICAL - SLAB - STEEL
MJ	10	ELECTRICAL LAYOUT
MJ	9	ELECTRICAL LAYOUT
G./JS	8	G.F. PLAN - ELEV - SECTION
MJ	7	SECTION
М.Н.	6	ELEVATIONS
PG.	5	ELEVATIONS
G/MC	4	FIRST FLOOR PLAN
BG	3	GROUND FLOOR PLAN
BY	2	SITE PLAN
	1	COVER SHEET
	SHEET	DESCRIPTION
	_	

#### ELECTRICAL TILES CARPET 12.05.22 AMENDED CABANA ZURCORP Н 11.05.22 COUNCIL DEFERRAL 20.01.22 HYDRAULIC CO - ORDINATED -G AIR CONDITIONING \_ F STEP DOWN TO REAR PG 14.12.21 STAIRS Ε 11.10.21 DA DRAWINGS & EXTERNAL COLOUR LANDSCAPE D 06.10.21 CABANA SETBACK AMENDED HYDRAULICS С 15.09.21 **ENGINEER** В CONTRACT DRAWINS PG 18.08.21 PEG OUT Α 16.07.21 TENDER REV DATE AMENDMENTS

**REV** 

CLIENT'S SIGNATURE:

QUOTE

KITCHEN

\_ DATE:

QUOTE NUMBER

DATE

## **Clarendon Homes**

BL No. 2298C ABN 18 003 892 706


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# ALL DIMENSIONS TO STRUCTURAL
ELEMENTS. DIMENSIONS TO BE READ
IN PREFERENCE TO SCALING.


PRODUCT:
BOSTON 42
Hamptons
L/H Garage


Sapphire Specification

Master Issued: 11.11.19 Revision: E

CLIENT: DA DRAWINGS Mr. QUACH Mrs. LE DRAWN: DATE: 18.08.21 SITE ADDRESS: PG. RATIO @ A3: CHECKED: Lot 6 No.19 N∖A MCA Boyd Avenue SHEET: JOB No: 29915249 NSW WEST PENNANT HILLS 2125

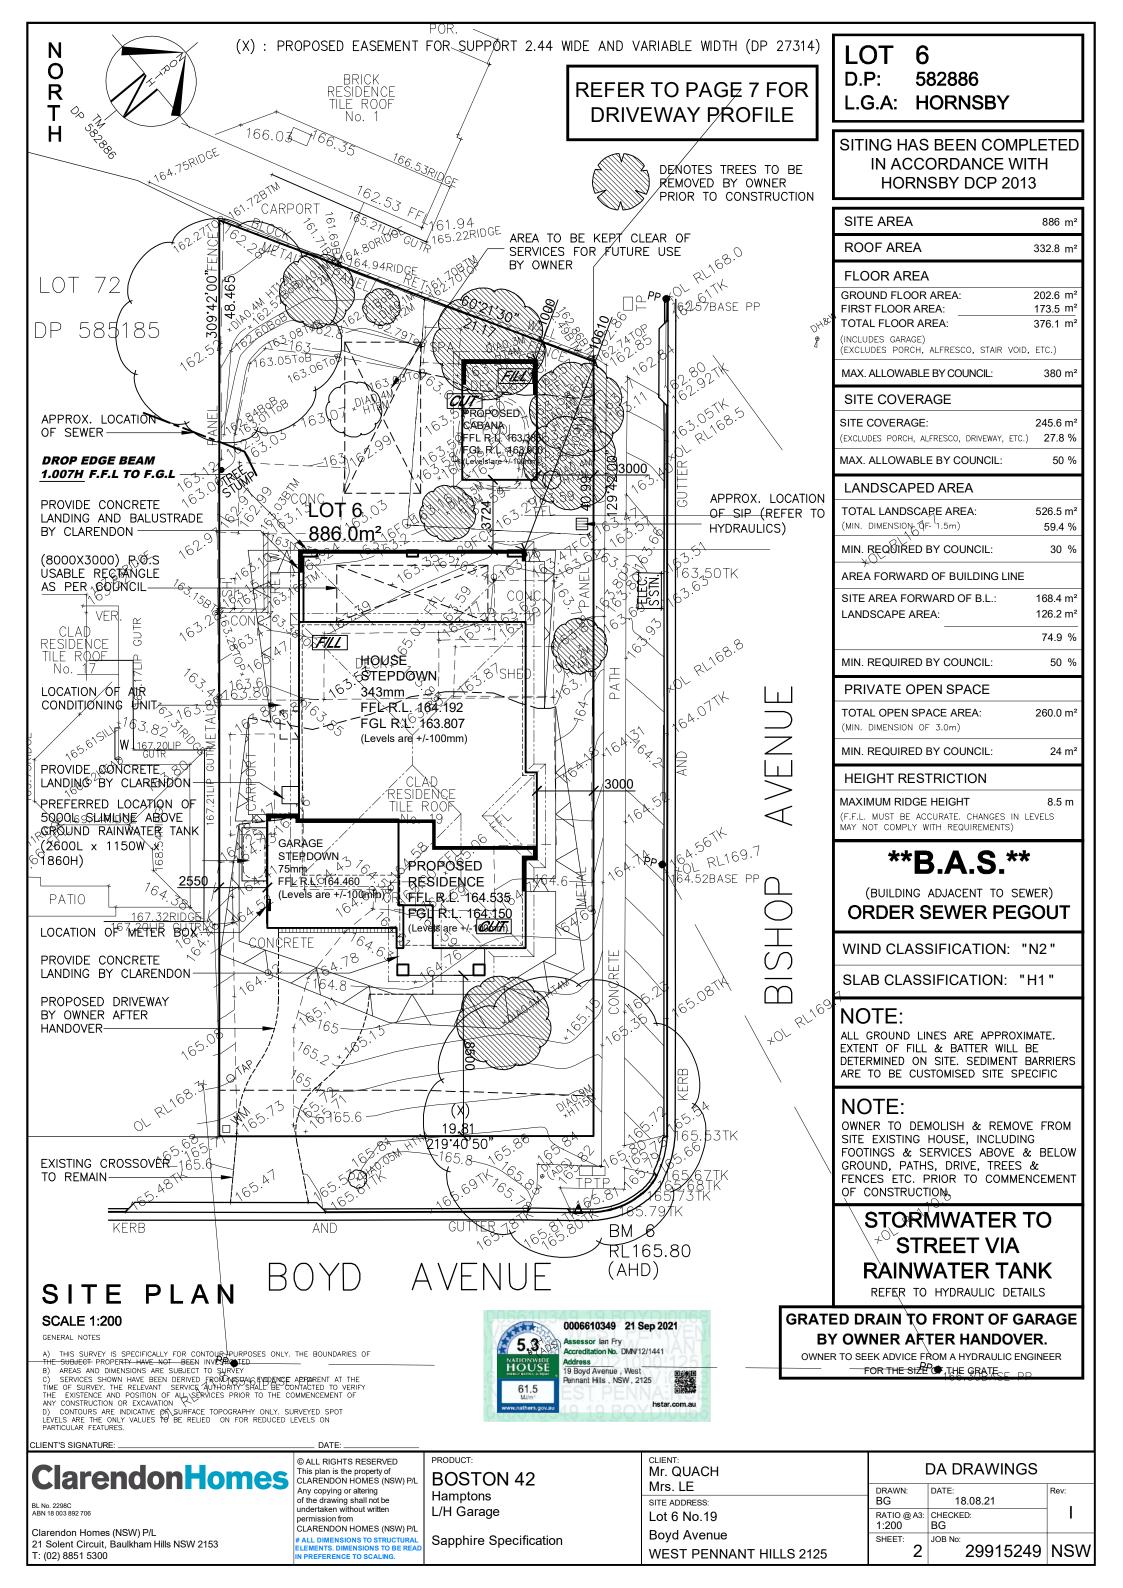

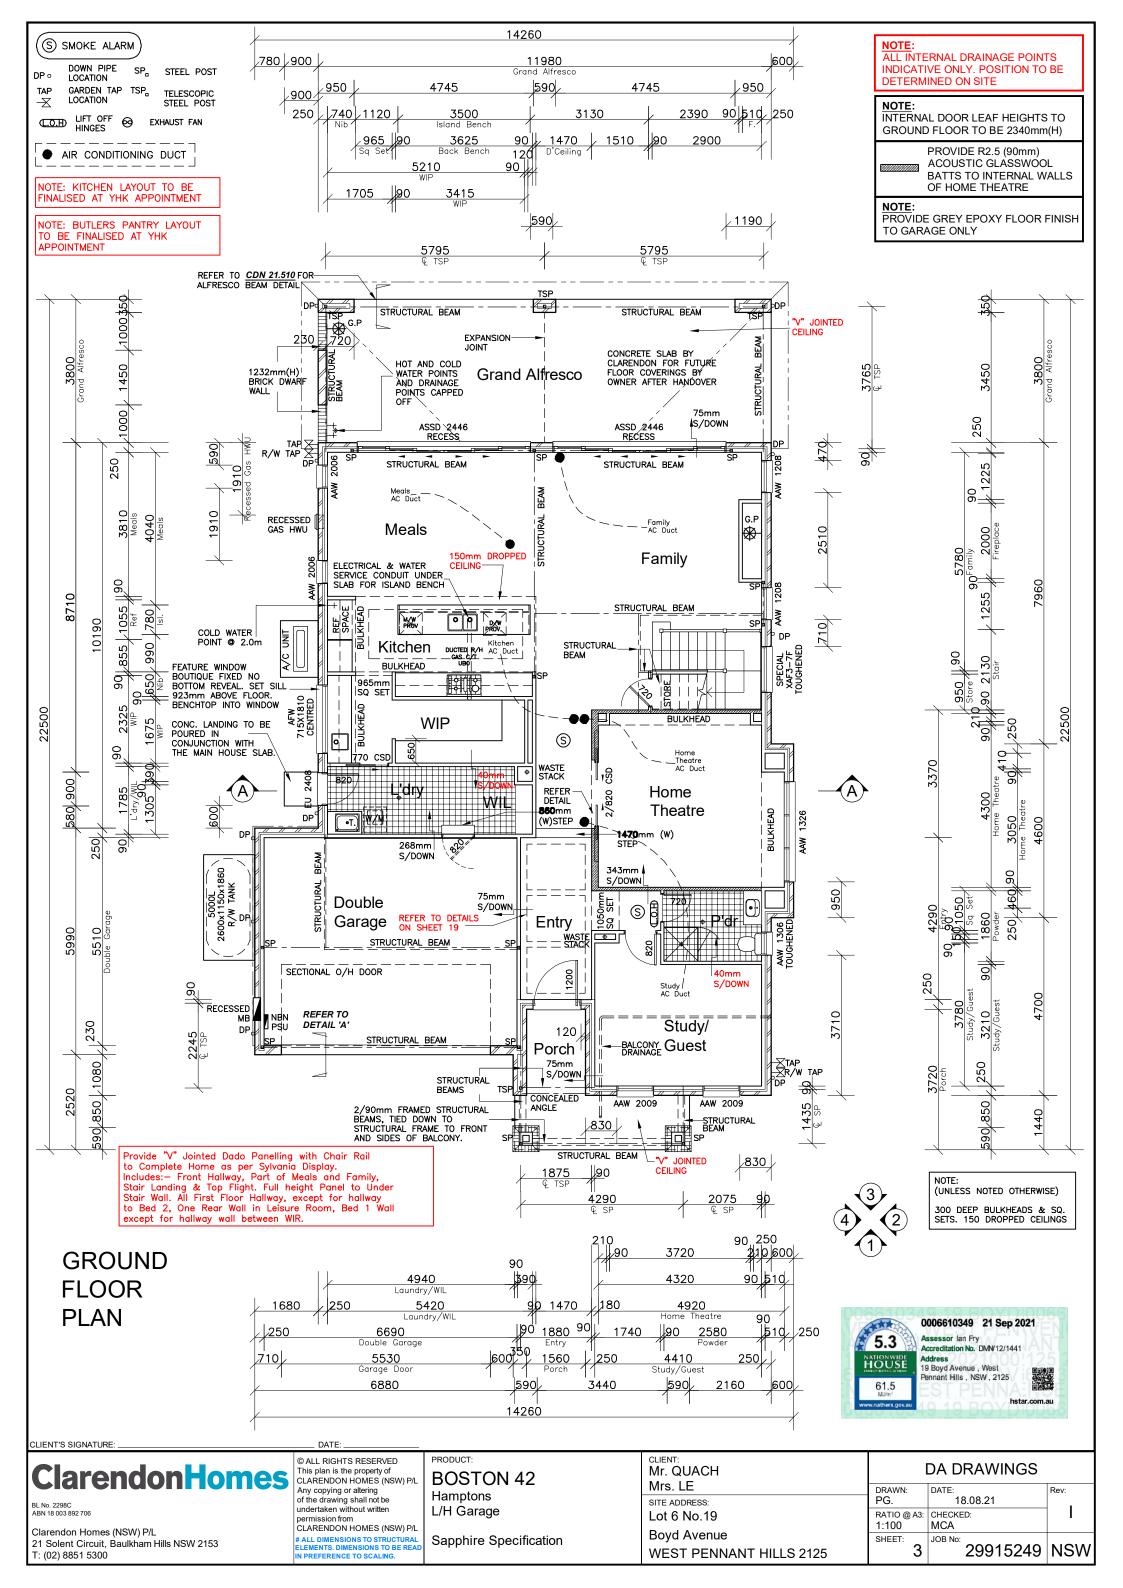

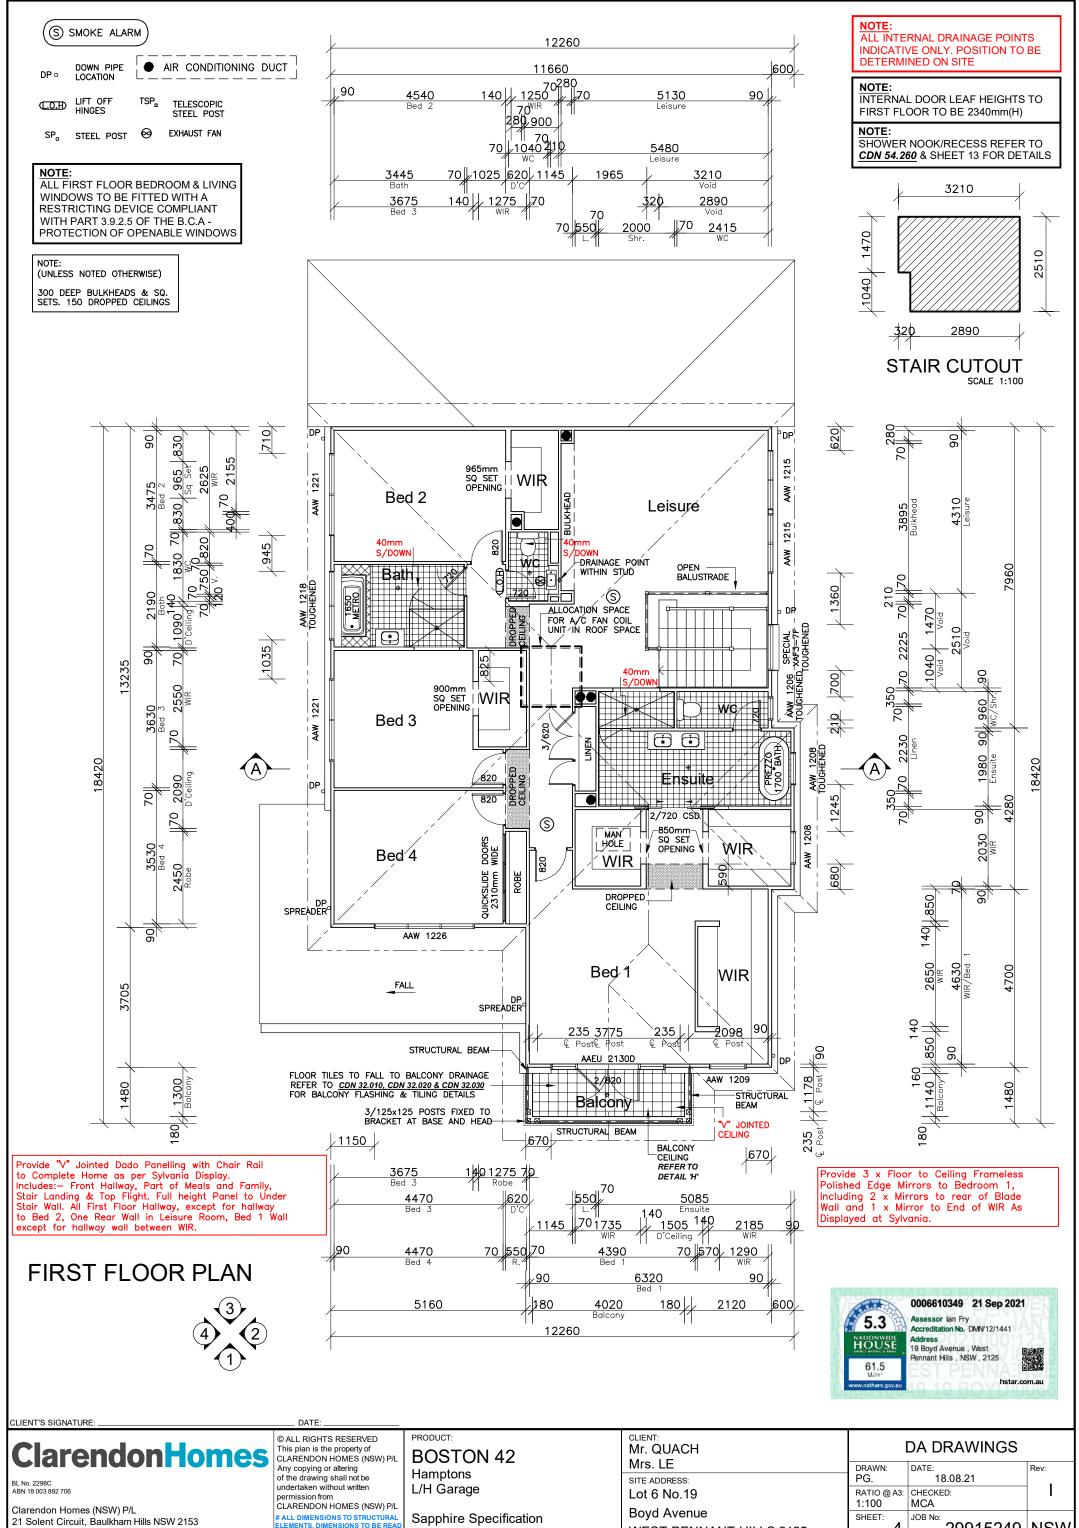

# ALL DIMENSIONS TO STRUCTURAL ELEMENTS. DIMENSIONS TO BE READ IN PREFERENCE TO SCALING.

T: (02) 8851 5300

Sapphire Specification

Boyd Avenue SHEET: JOB No: 29915249 NSW **WEST PENNANT HILLS 2125** 

NOTE:


ALL WINDOWS WITH BRICKWORK OVER TO HAVE MINIMUM OF 3 COURSES ABOVE LINTEL. EXTEND BRICKWORK ABOVE EAVE SOFFIT LINING IF REQUIRED NOTE:
HEIGHT OF DROP EDGE BEAM MAY VARY DUE TO SITE CONDITIONS


UPON COMPLETION OF SITE WORKS

NOTE: REFER TO SHEETS 13, 14 & 15 FOR ALL MOULDING & TIMBER TRIM DETAILS

RENDER FINISH TO BRICKWORK (UNLESS NOTED OTHERWISE)

NOTES: FOR DROP-OFF'S REFER TO FRAMING DETAILS CDN 21.010-21.080

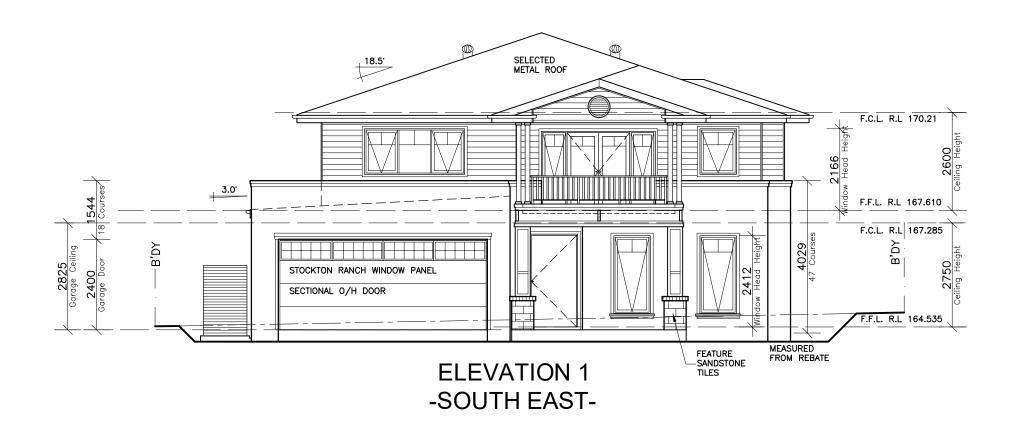

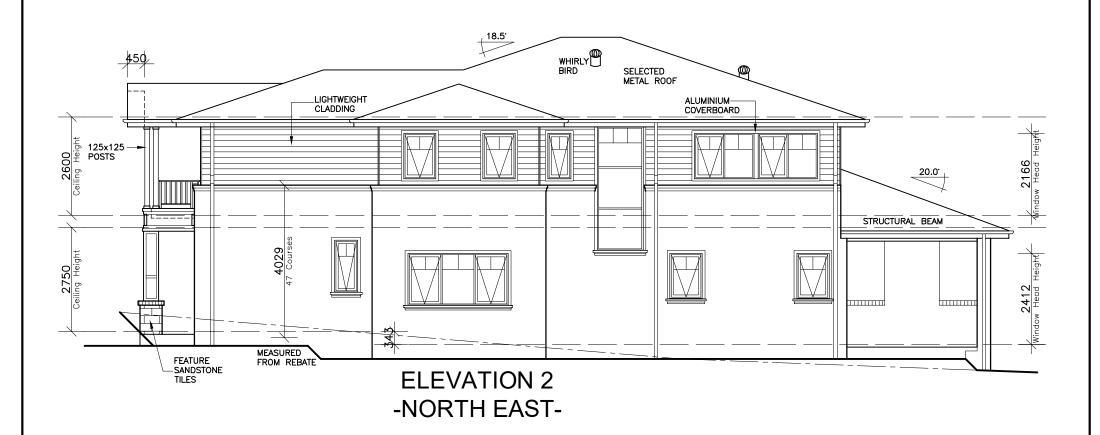



ClarendonHomes

BL No. 2298C ABN 18 003 892 706

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ELEMENTS. DIMENSIONS TO BE READ
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BOSTON 42
Hamptons
L/H Garage

Sapphire Specification

CLIENT: Mr. QUACH	DA DRAWINGS			
Mrs. LE	DRAWN:	DATE:	Rev:	
SITE ADDRESS:	PG.	18.08.21		
Lot 6 No.19	RATIO @ A3:	CHECKED:	l	
David Avenue	1:100	MCA		
Boyd Avenue	SHEET:	JOB No:		
WEST PENNANT HILLS 2125	5	29915249	NSW	

NOTE:


ALL WINDOWS WITH BRICKWORK OVER TO HAVE MINIMUM OF 3 COURSES ABOVE LINTEL. EXTEND BRICKWORK ABOVE EAVE SOFFIT LINING IF REQUIRED NOTE: HEIGHT OF DROP EDGE BEAM MAY VARY DUE TO SITE CONDITIONS

UPON COMPLETION OF SITE WORKS


NOTE: REFER TO SHEETS 13, 14 & 15 FOR ALL MOULDING & TIMBER TRIM DETAILS

RENDER FINISH TO BRICKWORK (UNLESS NOTED OTHERWISE)

NOTES: FOR DROP-OFF'S REFER TO FRAMING DETAILS CDN 21.010-21.080

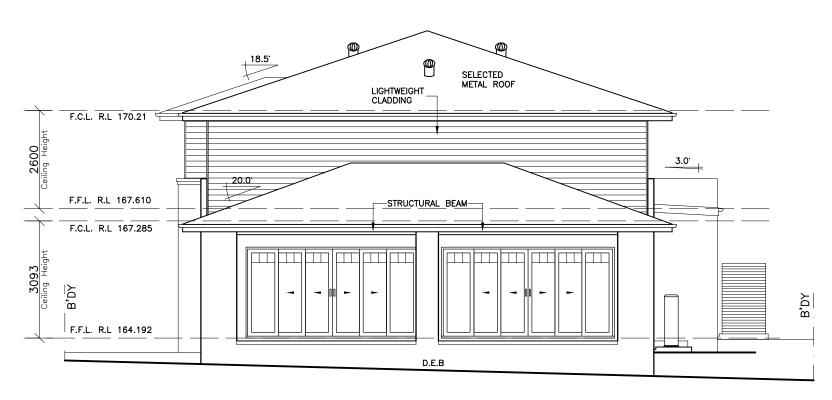

# **ELEVATION 3**-NORTH WEST-

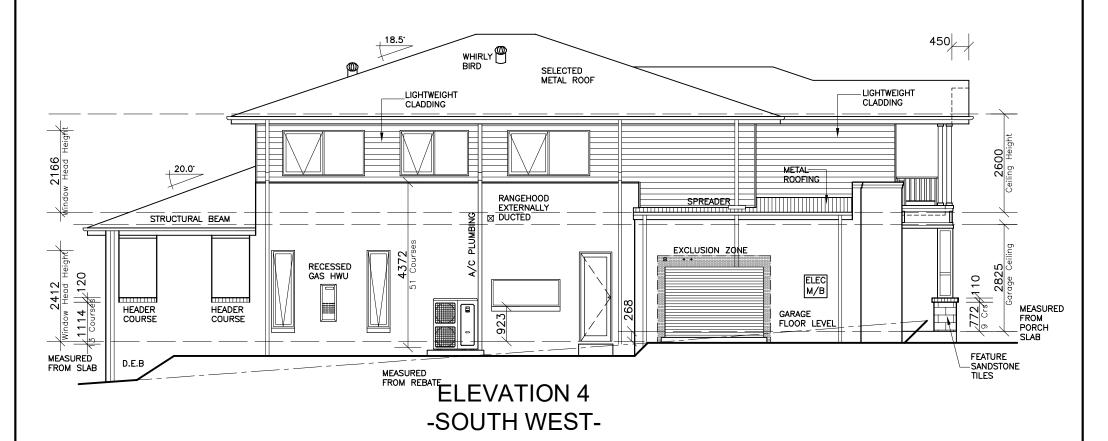



CLIENT'S SIGNATURE: \_

**ClarendonHomes** 

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ELEMENTS. DIMENSIONS TO BE READ
IN PREFERENCE TO SCALING.

PRODUCT:
BOSTON 42
Hamptons
L/H Garage

Sapphire Specification


CLIENT: DA DRAWINGS Mr. QUACH Mrs. LE DRAWN: DATE: Rev: PG. 18.08.21 SITE ADDRESS: RATIO @ A3: CHECKED: Lot 6 No.19 1:100 MCA Boyd Avenue SHEET: JOB No: 29915249 NSW WEST PENNANT HILLS 2125


NOTE:


ALL WINDOWS WITH BRICKWORK OVER TO HAVE MINIMUM OF 3 COURSES ABOVE LINTEL. EXTEND BRICKWORK ABOVE EAVE SOFFIT LINING IF REQUIRED

NOTE: HEIGHT OF DROP EDGE BEAM MAY VARY DUE TO SITE CONDITIONS UPON COMPLETION OF SITE WORKS NOTE: INTERNAL DOOR LEAF HEIGHTS TO GROUND & FIRST FLOOR TO BE 2340mm(H)

NOTES: FOR DROP-OFF's REFER TO FRAMING DETAILS CDN 21.010-21.080

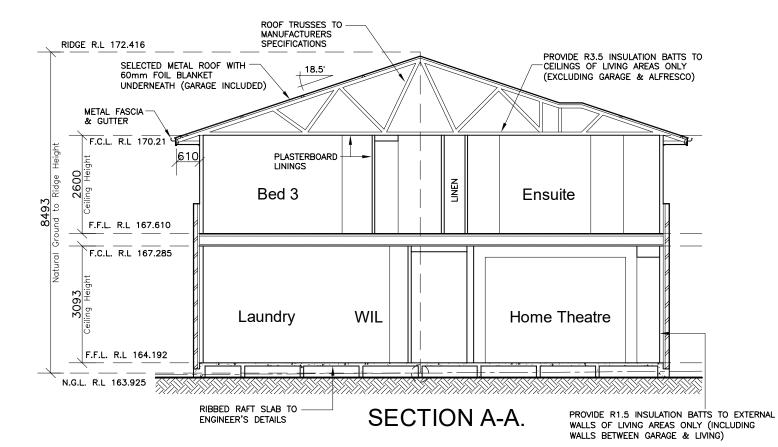

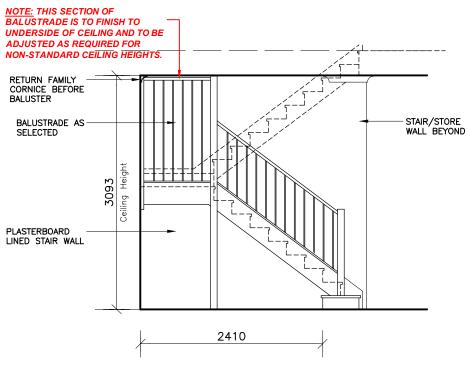


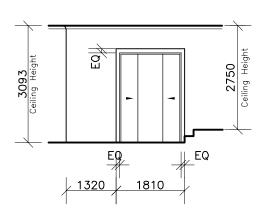


## HOME THEATRE DETAIL

VIEWED FROM HALLWAY SCALE: 1:100

#### STAIR ELEVATION SCALE: 1:50

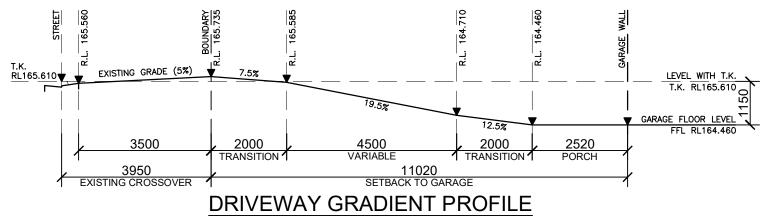

SCALE-1:100

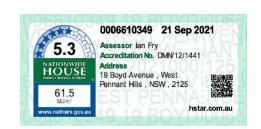

## **Clarendon Homes**

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PRODUCT: **BOSTON 42** Hamptons L/H Garage

Sapphire Specification

CLIENT: Mr. QUACH	DA DRAWINGS			
Mrs. LE	DRAWN:	DATE:	Rev:	
SITE ADDRESS:	PG.	18.08.21		
Lot 6 No.19	RATIO @ A3:	CHECKED:	l	
Boyd Avenue	1:100	MCA		
Boyd Avenue	SHEET:	JOB No: 0004 F0 40	NIONA	
WEST PENNANT HILLS 2125	/	29915249	NSW	

