



Vehicle Access To Site Detail

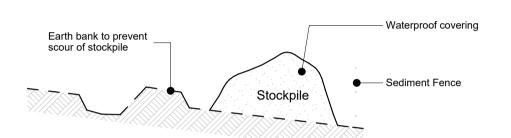

Building Material Stockpile Detail

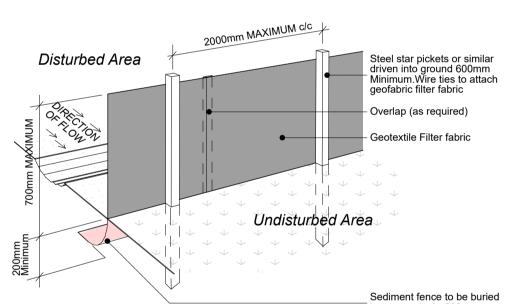

Geotextile Fabric Sediment Fence Details

SEDIMENTATION CONTROL NOTES


- 1: ALL EROSION CONTROL MEASURERS ARE TO BE INSTALLED & MAINTAINED IN ACCORDANCE WITH MANAGING URBAN STORMWATER , 3rd EDITION PRODUCED BY THE NSW DEPARMENT OF HOUSING, STANDARD DRAWING (SO) NUMBERS REFERENCE CAN BE OBTAINED FROM THIS PUBLICATION
- 2 : ALL EROSION & SILATION CONTROL DEVICES ARE TO BE PLACED PRIOR TO THE COMMENCEMENT OF ANY CONSTRUCTIONWORKS, & ALL SILT TRAPS ARE TO HAVE DEPOSITED SILT REMOVED REGULARY DURING CONSTRUCTION
- 3: ALL TREES ARE TO BE PRESERVED UNLESS INDICATED OTHERWISE ON COUCIL APPROVED DEVELOPMENT CONSENT. EXISTING GRASS COVER SHALL BE MAINTAINED EXCEPT IN AREAS CLEARED FOR BUILDINGS, PAVEMENT ETC.
- 4 : INSTALL TEMPORARY SEDIMENT BARRIERS TO ALL INLET PITS, LIKELY TO COLLECTSILT LADDEN WATER
- 5: NOT WITHSTANDING DETAILS SHOWN IT IS THE CONTRACTORS SOLE RESPONSIBILTY TO ENSURE THAT ALL SITE ACTIVITIES COMPLY WITH THE REQUIREMENTS OF THE CLEAN WATERS ACT & ALL COUNCIL REQUIREMENTS

The builder shall check and verify all dimensions and levels and verify all errors and omissions to the Architect. Do not scale the drawings. Drawings shall not be used for construction purposes until issued by the Architect for construction.

All works to be set out by registered surveyor.

I.L. New & Associates MBDA, NSW

PO Box 58 Kurmond 2754 NSW Ph: 0416 041 027

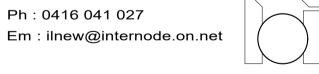

Association of NSW Inc.

Checked By:

Layout No.

Richard and Jo-Anne Green

Project Name: PROPOSED SECOND FLOOR ADDITION AND INTERNAL ALTERATIONS TO AN EXISITNG MULTI-STOREY DWELLING


Lots 21 DP499759 , No66 Calabash Point Berowra Waters LGA Hornsby


Drawing Title: - Sedimentation Control Plan Sedimentation Control Plan, Sedimentation Control Scale: as noted Date:


Project No: 080601

Plot Date:

Status: preliminary design

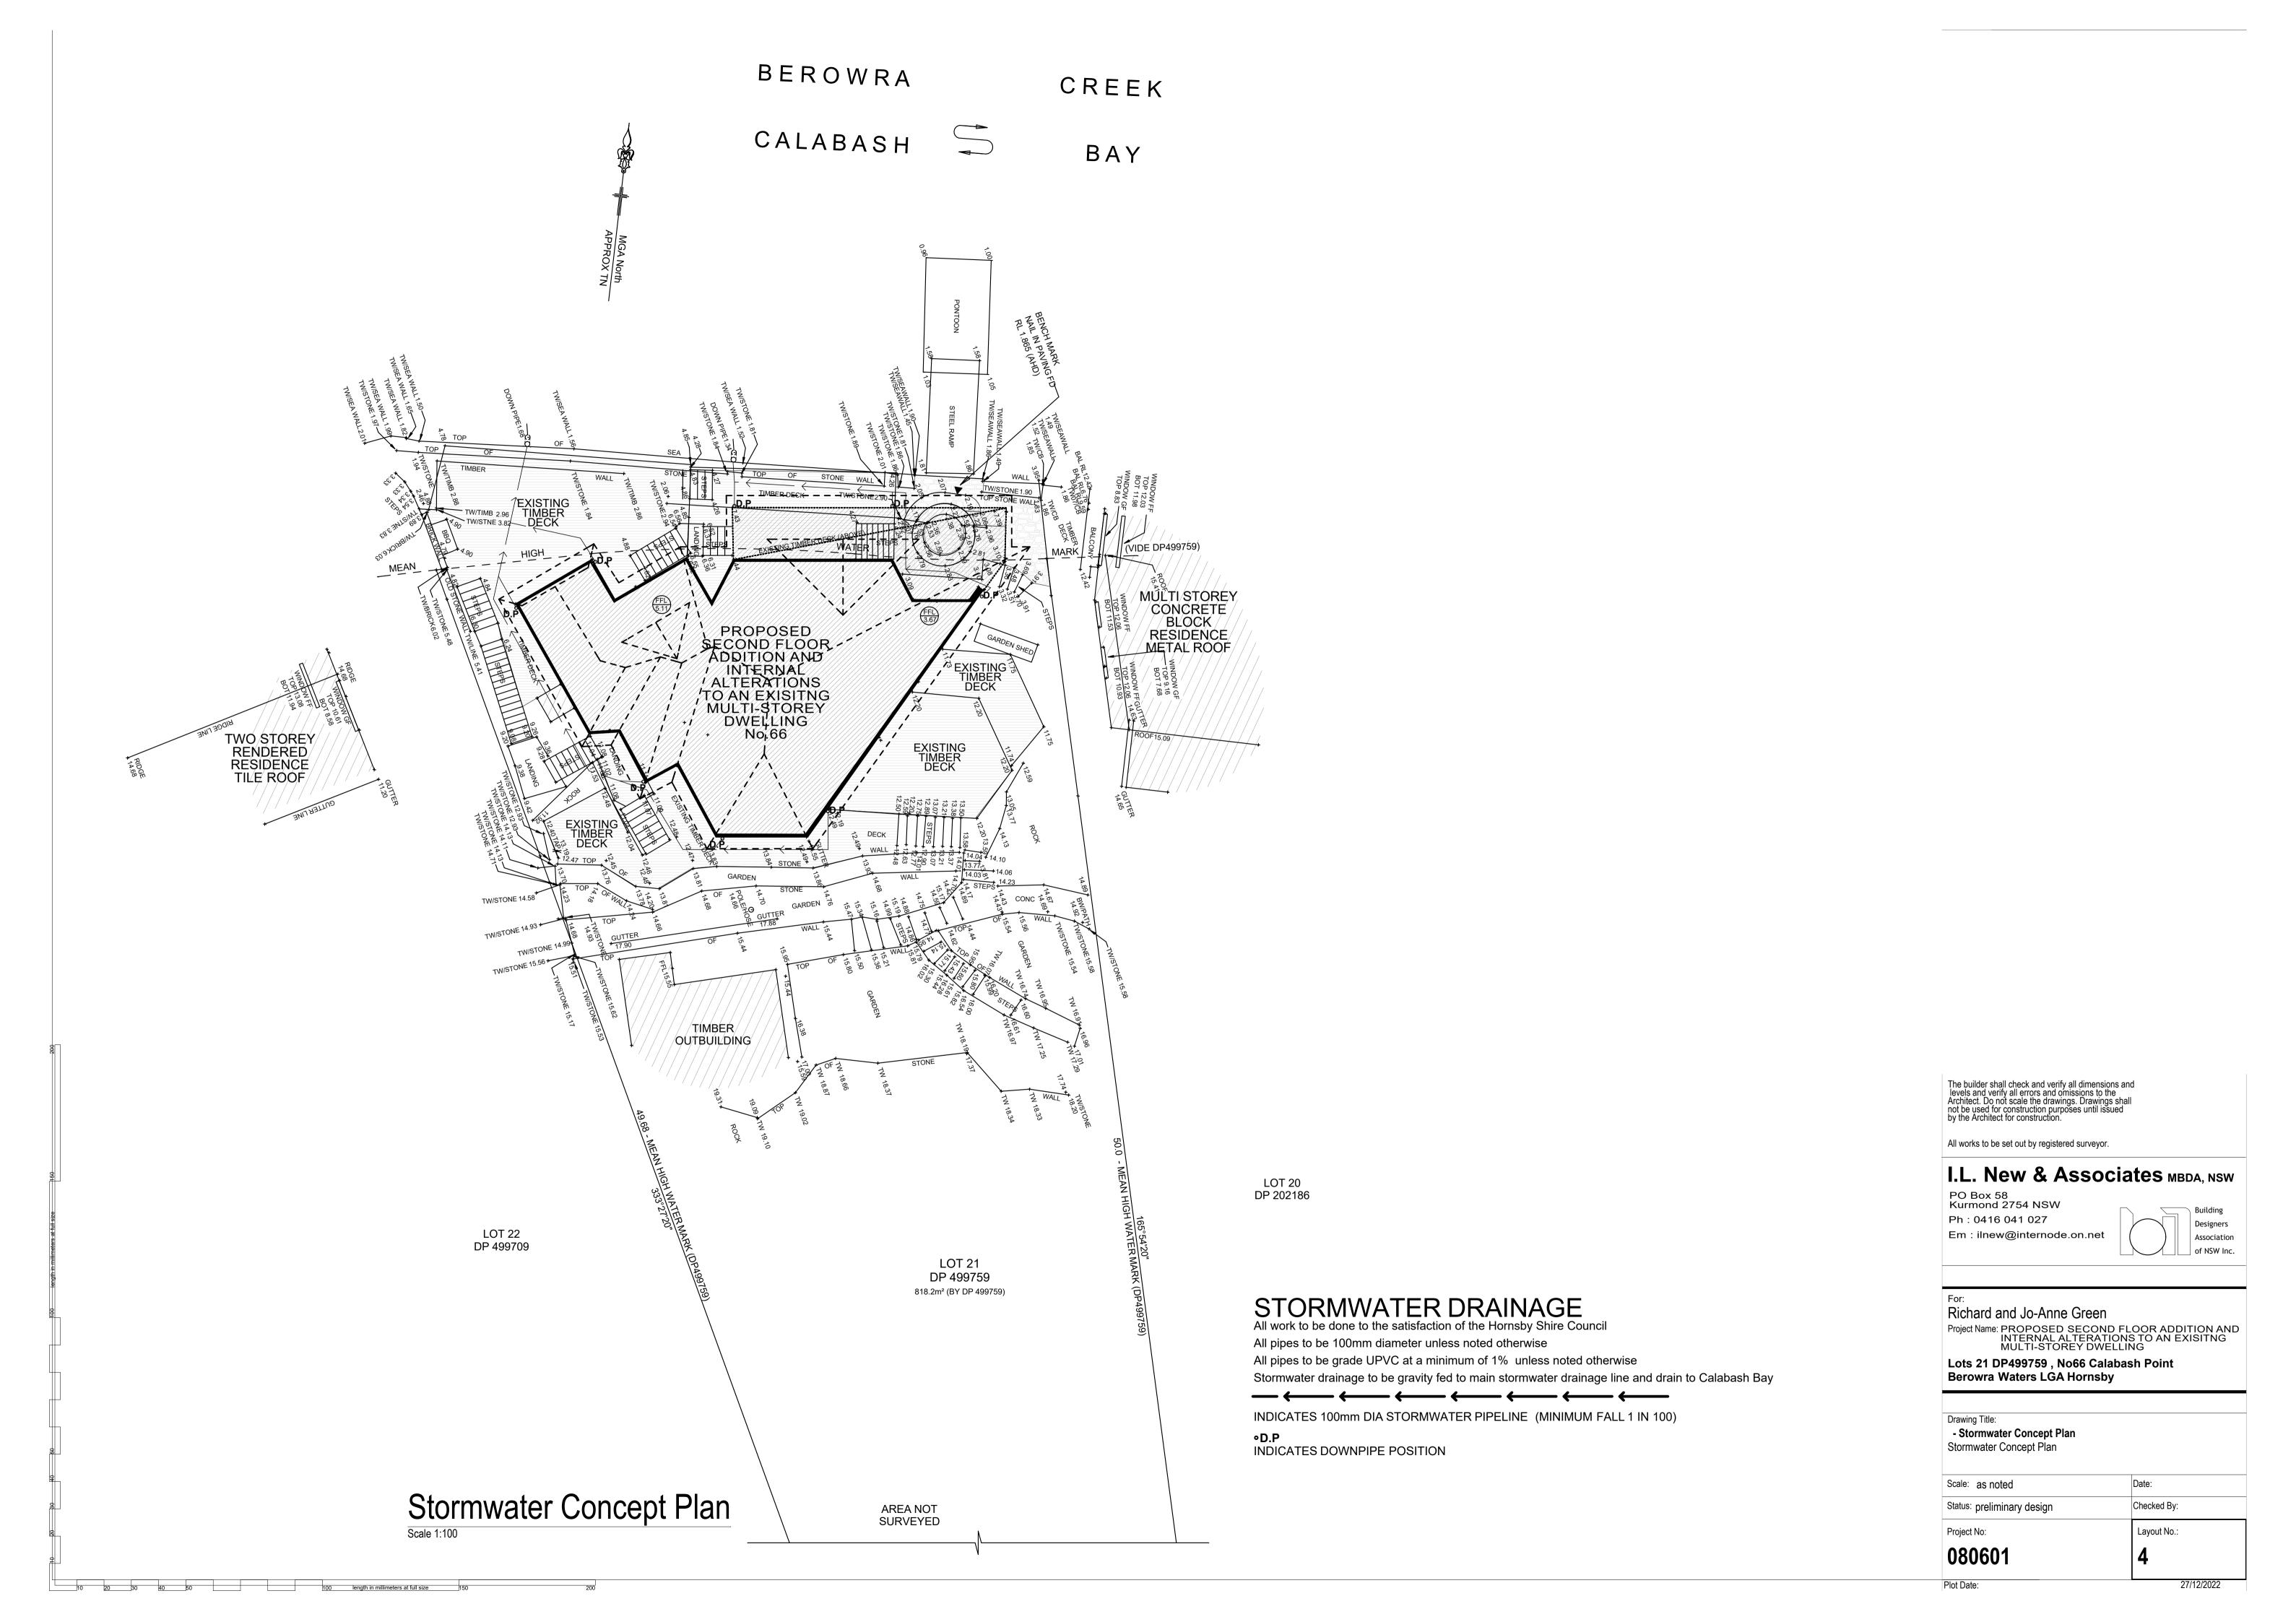

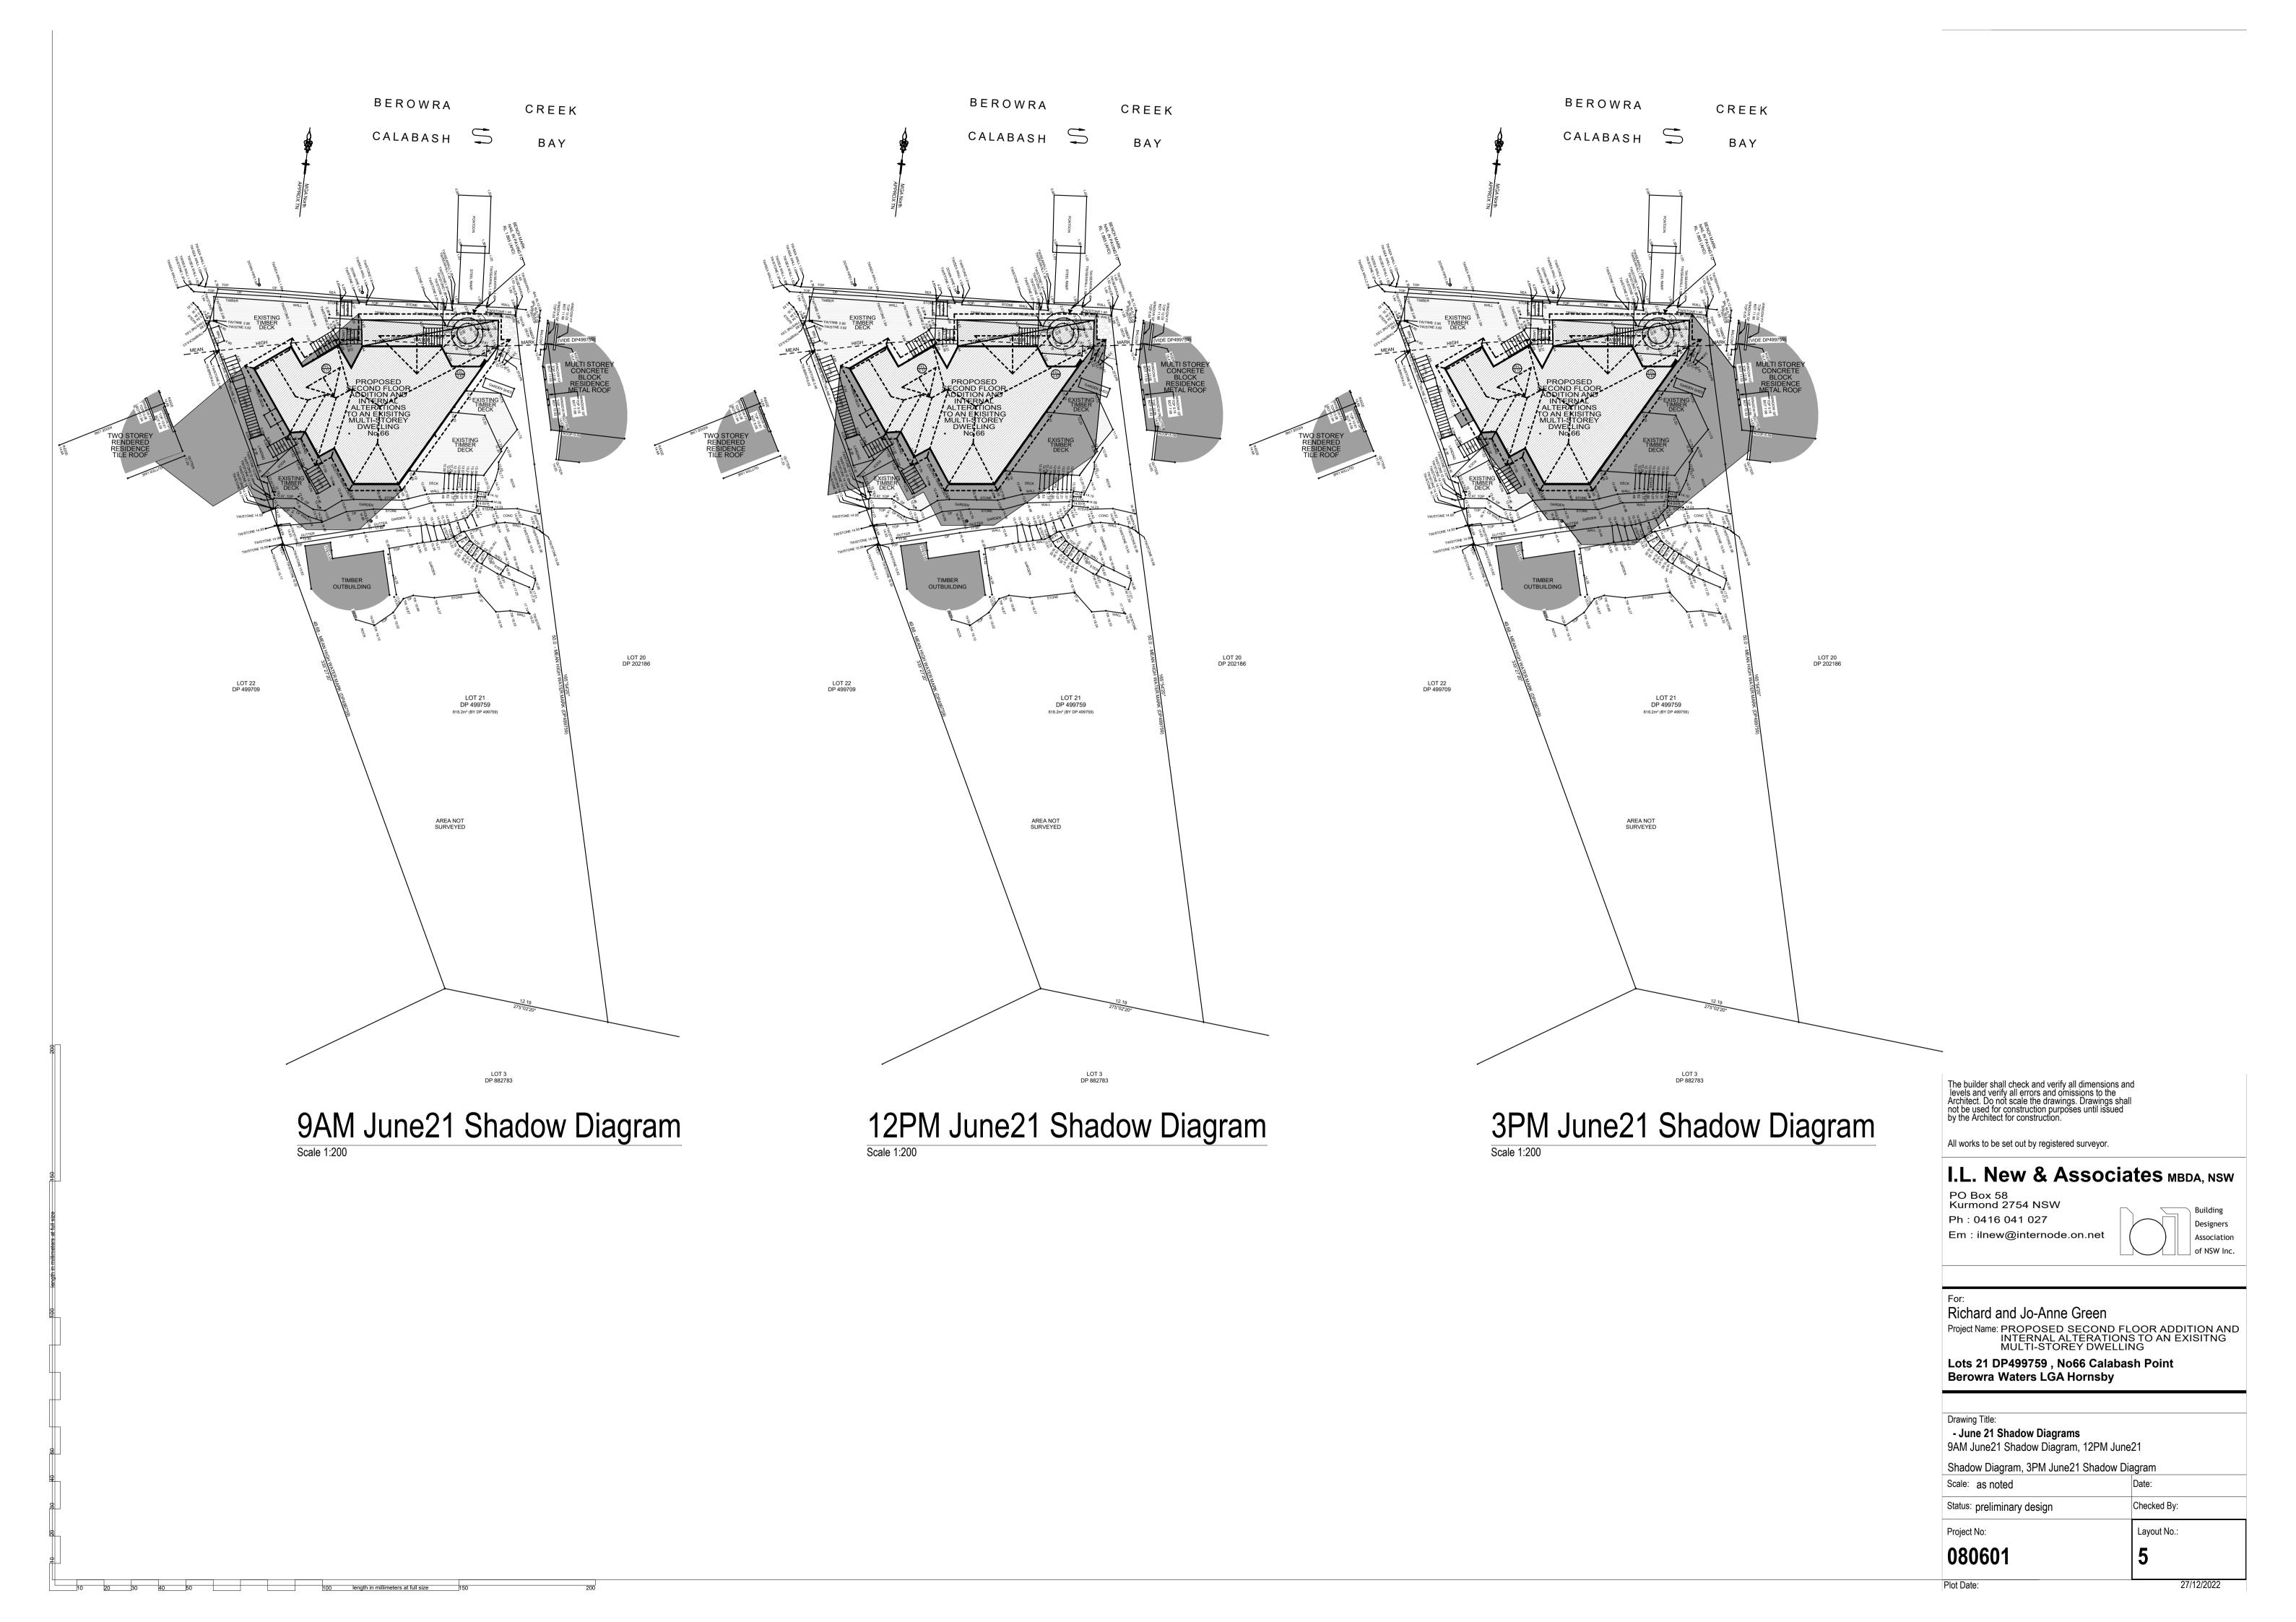

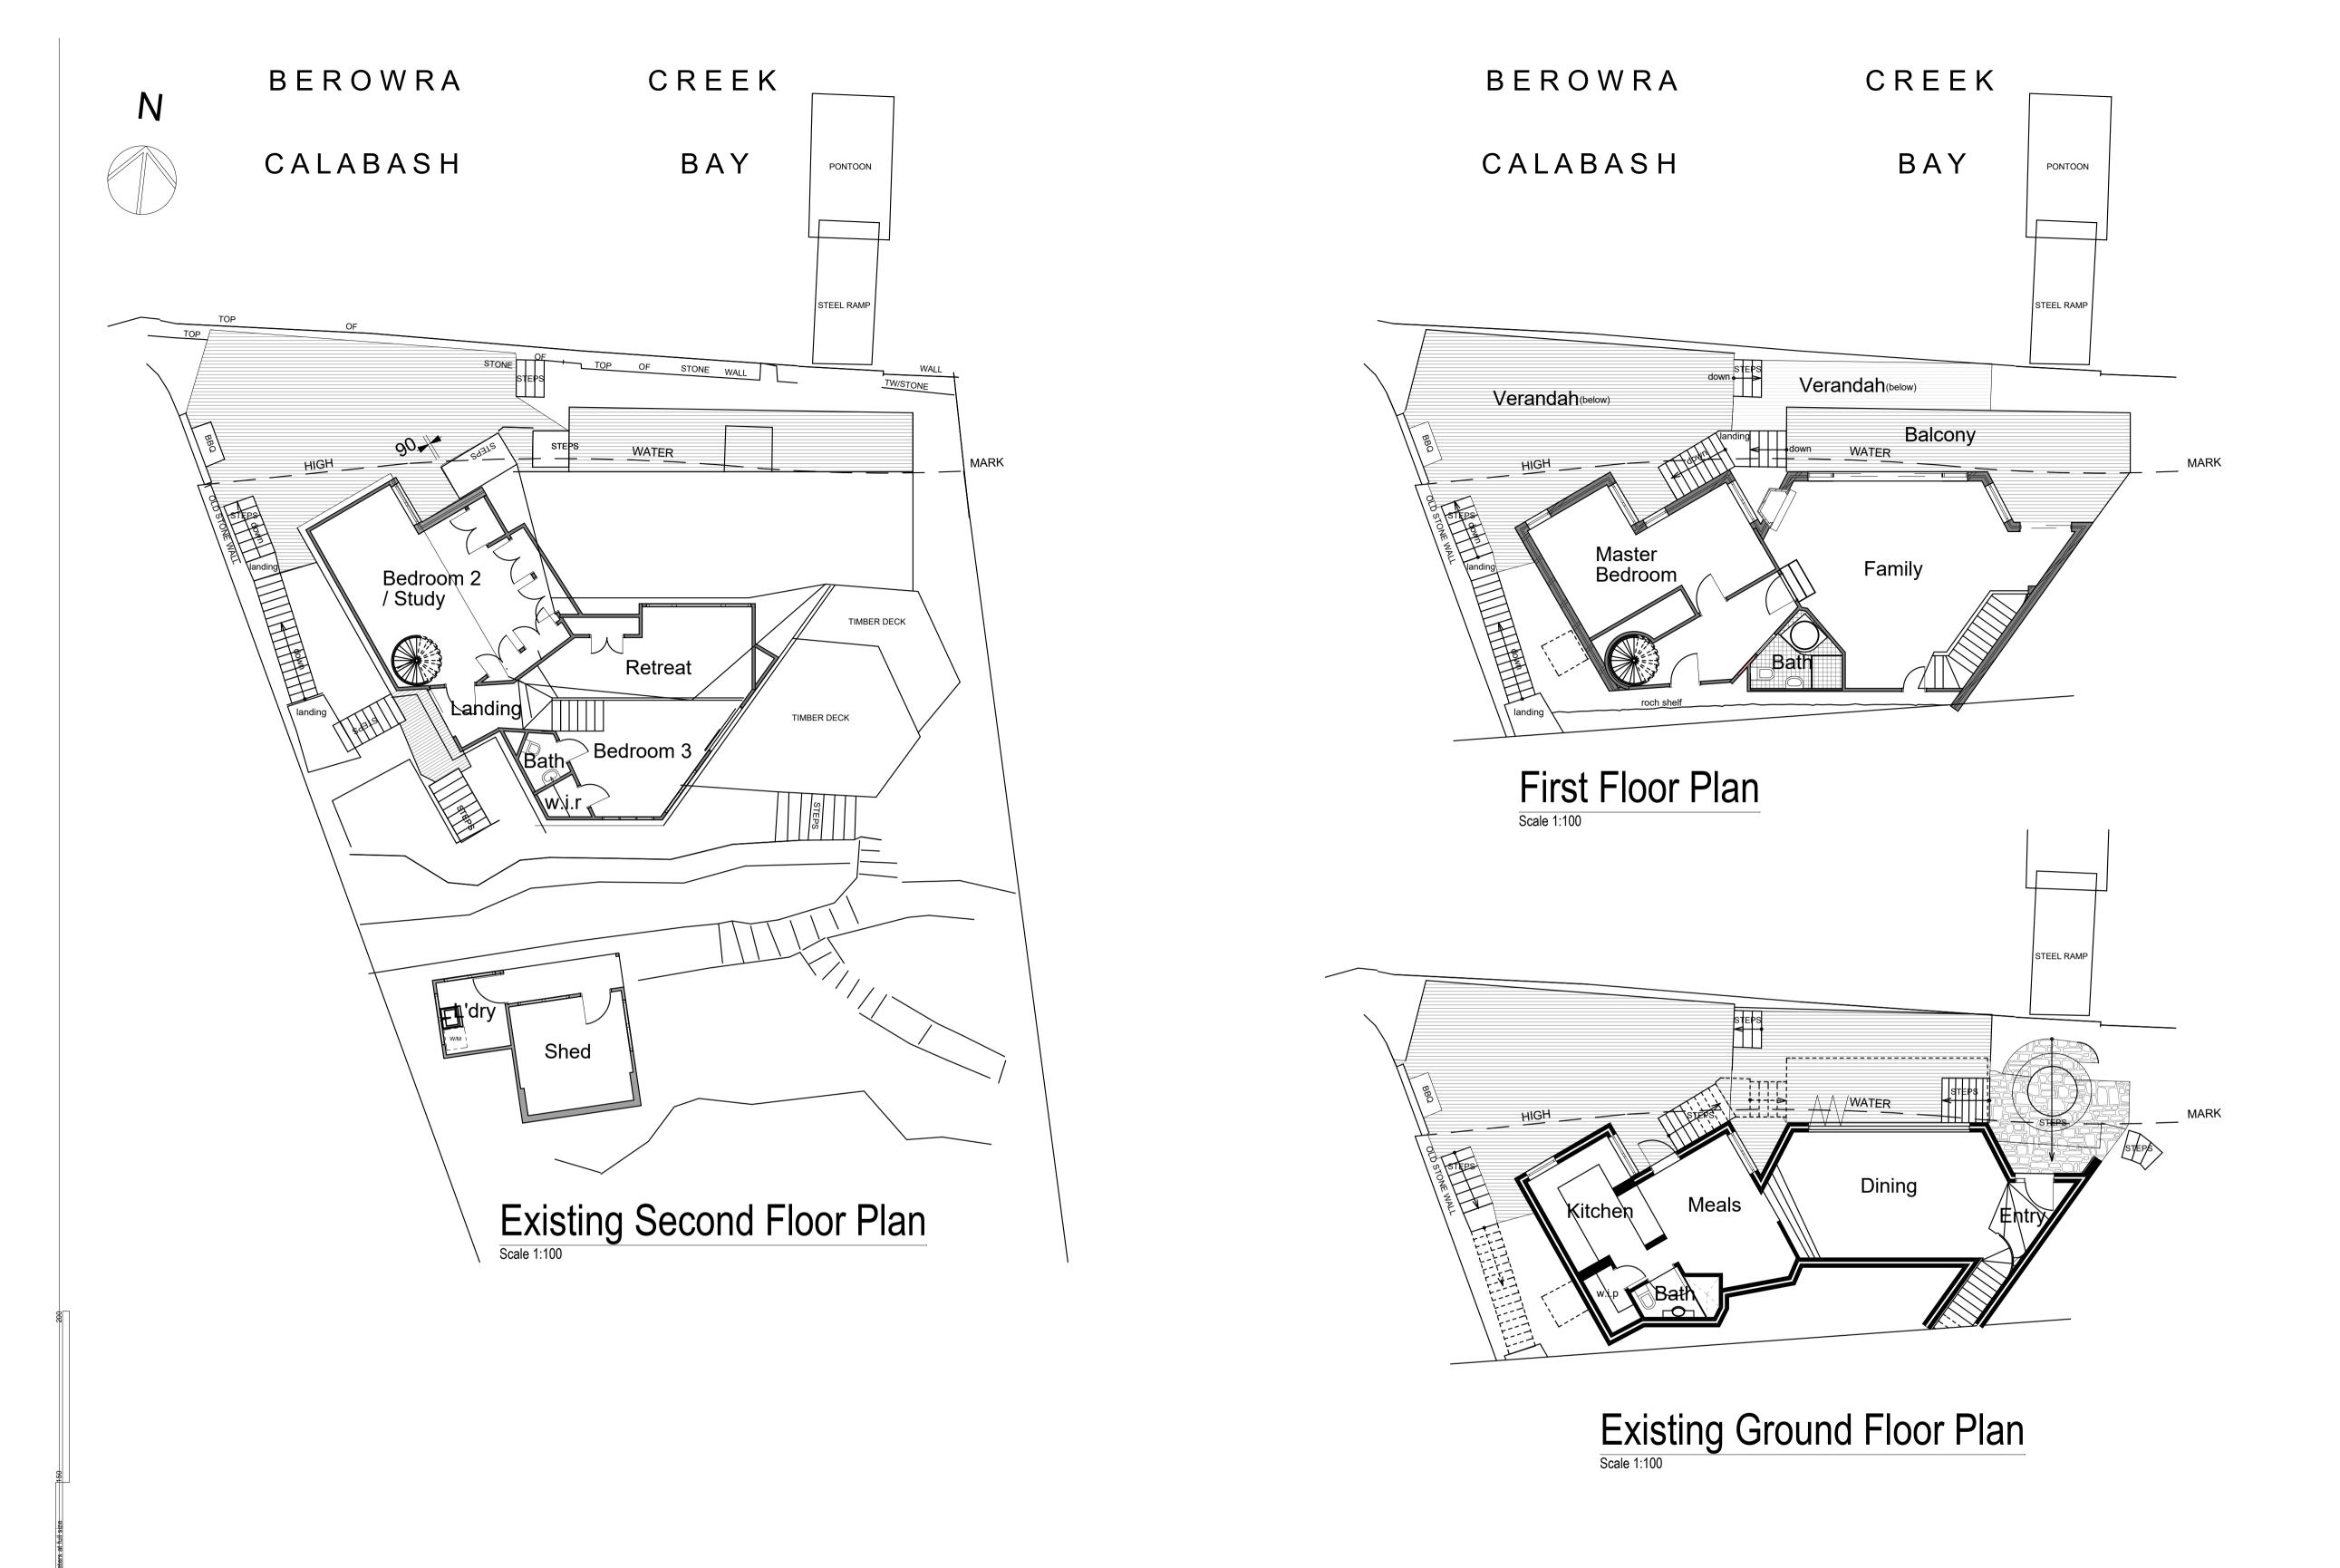

10 20 30 40 50 100 length in millimeters at full size 150

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Association

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Project Name: PROPOSED SECOND FLOOR ADDITION AND INTERNAL ALTERATIONS TO AN EXISITNG MULTI-STOREY DWELLING

Lots 21 DP499759 , No66 Calabash Point Berowra Waters LGA Hornsby

- Exisitng Floor Plans Existing Second Floor Plan, First Floor Plan, Existing Ground Floor Plan


Scale: as noted

Status: preliminary design Checked By:

Project No: 080601

Plot Date:

Layout No.

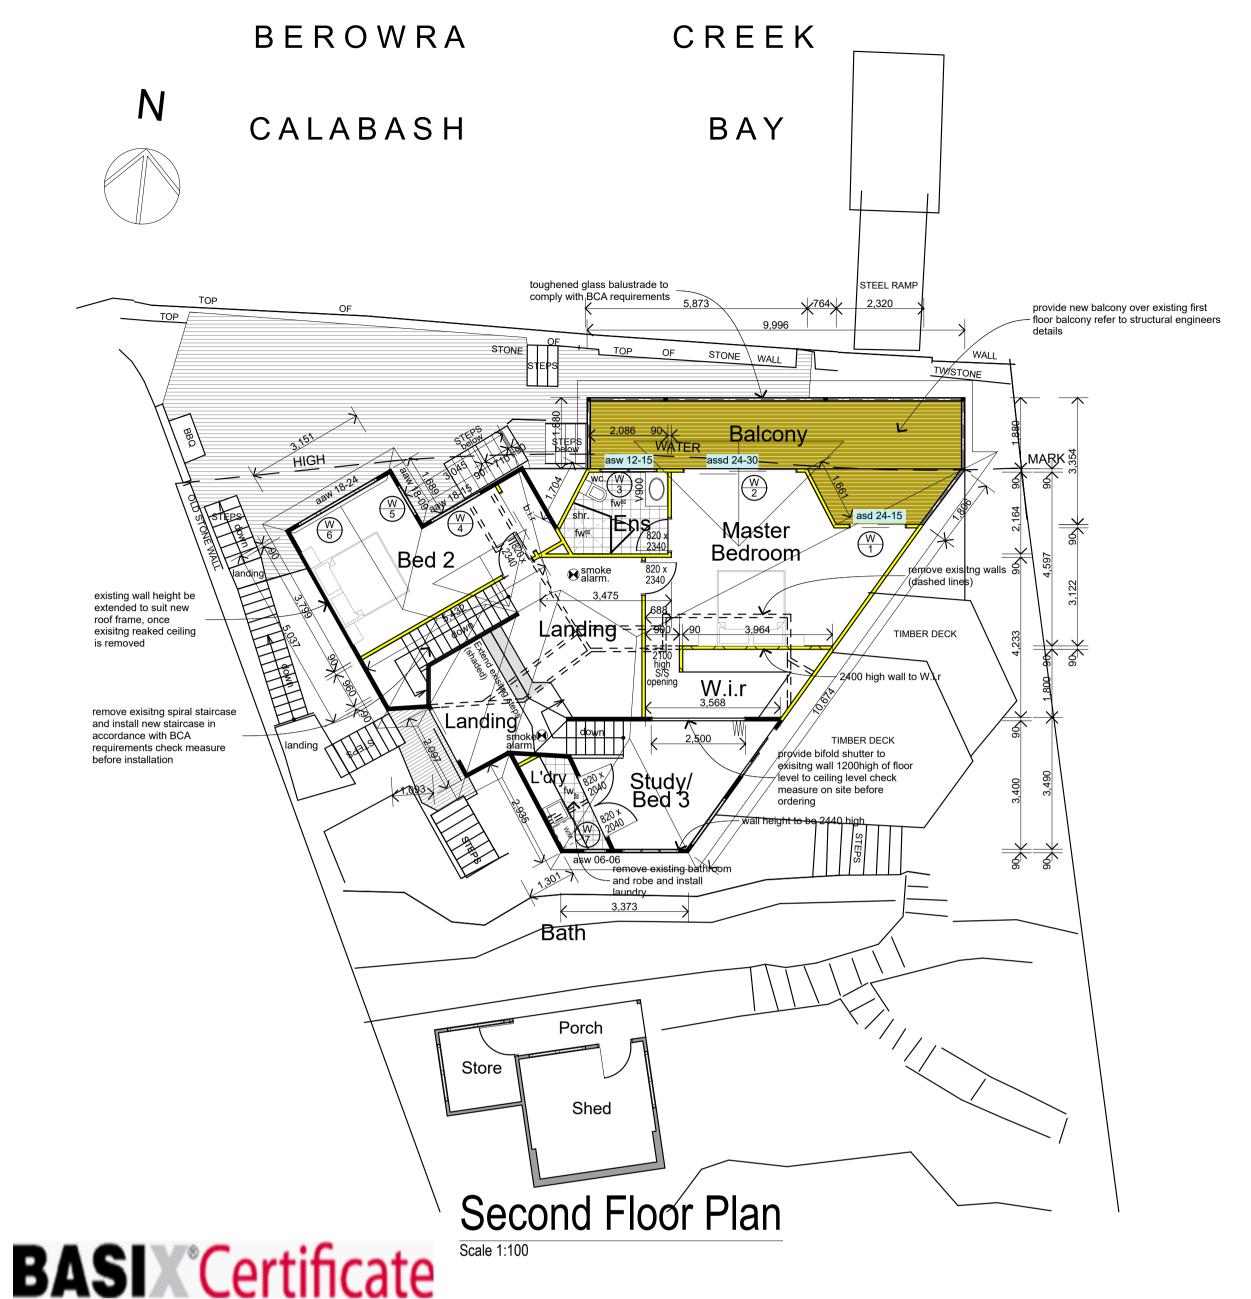

Alterations and Additions

Certificate number: A479681

Fixtures and systems

The applicant must ensure a minimum of 40% of new or altered light fixtures are fitted with fluorescent, compact fluorescent, or light-emitting-diode (LED) lamps.

Fixtures The applicant must ensure new or altered showerheads have a flow rate no greater than 9 litres per minute or a 3 star water rating. The applicant must ensure new or altered toilets have a flow rate no greater than 4 litres per average flush or a minimum 3 star water rating. The applicant must ensure new or altered taps have a flow rate no greater than 9 litres per minute or minimum 3 star water rating.

Construction

Insulation requirements

The applicant must construct the new or altered construction (floor(s), walls, and ceilings/roofs) in accordance with the specifications listed in the table below, except that a) additional insulation is not required where the area of new construction is less than 2m2, b) insulation specified is not required for parts of altered construction where insulation already exists.

Construction	Additional insulation required (R-value)	Other specifications
suspended floor with open subfloor: framed (R0.7).	R0.8 (down) (or R1.50 including construction)	
external wall: framed (weatherboard, fibro, metal clad)	R1.30 (or R1.70 including construction)	
flat ceiling, pitched roof	ceiling: R1.95 (up), roof: foil backed blanket (55 mm)	dark (solar absorptance > 0.70)
raked ceiling, pitched/skillion roof: framed	ceiling: R2.24 (up), roof: foil backed blanket (55 mm)	dark (solar absorptance > 0.70)


Glazing requirements

Windows and glazed doors

10 20 30 40 50 100 length in millimeters at full size 150

The applicant must install the windows, glazed doors and shading devices, in accordance with the specifications listed in the table below. Relevant overshadowing specifications must be satisfied for each window and glazed door. The following requirements must also be satisfied in relation to each window and glazed door: Each window or glazed door with standard aluminium or timber frames and single clear or toned glass may either match the description, or, have a U-value and a Solar Heat Gain Coefficient (SHGC) no greater than that listed in the table below. Total system U-values and SHGCs must be calculated in accordance with National Fenestration Rating Council (NFRC) conditions. Each window or glazed door with improved frames, or pyrolytic low-e glass, or clear/air gap/clear glazing, or toned/air gap/clear glazing must have a U-value and a Solar Heat Gain Coefficient (SHGC) no greater than that listed in the table below. Total system U-values and SHGCs must be calculated in accordance with National Fenestration Rating Council (NFRC) conditions. The description is provided for information only. Alternative systems with complying U-value and SHGC may be substituted. For projections described in millimetres, the leading edge of each eave, pergola, verandah, balcony or awning must be no more than 500 mm above the head of the window or glazed door and no more than 2400 mm above the sill. Pergolas with polycarbonate roof or similar translucent material must have a shading coefficient of less than 0.35. Pergolas with fixed battens must have battens parallel to the window or glazed door above which they are situated, unless the pergola also shades a perpendicular window. The spacing between battens must not be more than 50 mm.

Window / door no.	Orientation	Area of glass inc. frame (m2)	Oversha Height (m)	dowing Distance (m)	Shading device	Frame and glass type
W 1	N	3.6	0	0	eave/verandah/pergola/balcony >=900 mm	standard aluminium, single clear, (or U-value: 7.63, SHGC: 0.75)
W2	N	7.2	0	0	eave/verandah/pergola/balcony >=900 mm	standard aluminium, single clear, (or U-value: 7.63, SHGC: 0.75)
W3	N	1.8	0	0	eave/verandah/pergola/balcony >=900 mm	standard aluminium, single clear, (or U-value: 7.63, SHGC: 0.75)

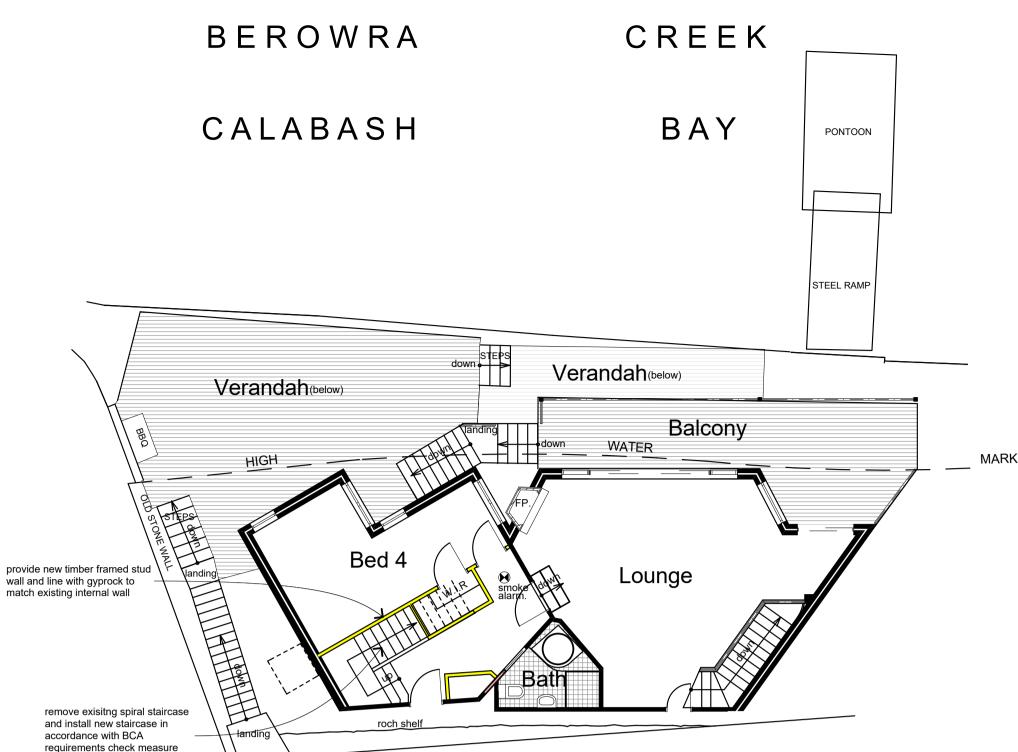

First Floor Plan

CREEK BEROWRA CALABASH BAY PONTOON Dining

Ground Floor Plan

Window / door no .	Orientation	Area of glass inc. frame (m2)	Overshadowing		Shading device	Frame and glass type
			Height (m)	Distance (m)		
W4	NW	2.7	0	0	eave/verandah/pergola/balcony >=600 mm	improved aluminium, single pyrolytic low-e, (U-value: 4.48, SHGC: 0.46)
W5	NE	1.62	0	0	eave/verandah/pergola/balcony >=600 mm	improved aluminium, single pyrolytic low-e, (U-value: 4.48, SHGC: 0.46)
W6	NW	4.32	0	0	eave/verandah/pergola/balcony >=600 mm	improved aluminium, single pyrolytic low-e, (U-value: 4.48, SHGC: 0.46)
W7	S	0.36	0	0	eave/verandah/pergola/balcony >=600 mm	standard aluminium, single clear, (or U-value: 7.63, SHGC: 0.75)

before installation

BCA Notes

1. NOTE: All plans are to be read in conjuncon and comply with the BASIX Cerficate, Bushfire and Geotech Reports

2. IMPORTANT NOTE: Any proposed product changes aer approval of the CC to be immediately nofied to the PrivateCerfying Authorityfor concurrence

3. Termite Control shall be in accordance with N.C.C. 2019 Vol 2 Part 3.1.4. and AS 3660.1. 4. All external mber framed walls to be wrapped in a

breathable vapour permeable membrane that complies + installed with AS/NZS 4200.1 + AS/NZS

5. Metal Roof Design and Installaon shall be in accordance with N.C.C 2019 Vol 2 Part 3.5.1. AS/NZS 1562

6. All external wall Claddings must be complaint with

the requirements of N.C.C. 2019 Vol 2 Part 3.5.4. deemed to sasfy provisions and AS/NZS 1859.4. 7. All Balustrades to comply with N.C.C. 2019 Vol 2 Part 3.9 and AS 1684, AS 1170, AS 1288 and AS/NZS 2208

8. All stairs providing access to comply with N.C.C. 2019 Vol2 Part 3.9.1 & 3.9.2 and AS 4586 including slip resistance P3 / R10 for Dry or P4 / R11 for

9. All windows to be restricted in accordance with N.C.C 2019 Vol 2 Part 3.9.2.6 & Part 3.9.2.7. Protecon of openable windows where floor below is greater than 2 meters 10. Allow for separate taps for the washing machine and keep separate for those of the laundry tub.
A dedicated laundry space comprising of at least on washtub and space for washing machine must be provided in accordance with N.C.C. 2019 Vol 2 Part

11. Provide Plasterboard Lining installed to ManufacturersSpecificaons & AS 2589 12. All waterproofing to AS3740 and N.C.C 2019 Vol 2 Part 3.8.1. Provide a Guaranteed Flexible Waterproof Membrane to all Wet Area Floors & Shower

walls to manufacturedinstrucons. 13. Provide li off hinges where pan is within 1.2 metres of hinged side of door in accordance with N.C.C 2019 Vol 2 Part 3.8.3. 14. Proved hardwired & interconnected smoke alarm devices. Smoke alarms to be installed to AS 3786 and the N.C.C. 2019 Vol 2 Part 3.7.5. 15. Inter-tenancy walls between primary and secondary dwelling (Granny Flats) must be constructed from a tested system that achieves a 60/60/60 as per N.C.C 2019 Vol 2 Part 3.7.3. and N.C.C 2019 Vol 2 Part 3.8.6. Sound Insultaon RW and CTR 50 or

16. Condensaon Management must be adhered to in accordance with N.C.C. 2019 Vol 2 Part 3

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Lots 21 DP499759, No66 Calabash Point Berowra Waters LGA Hornsby

Drawing Title: - Floor Plans Ground Floor Plan, First Floor Plan, Second Floor Plan. Section A:A Scale: as noted Status: preliminary design Checked By: Layout No.

Plot Date:

080601

